
ROAD AND DRAINAGE PLAN

ASH ROAD, LEOPOLD

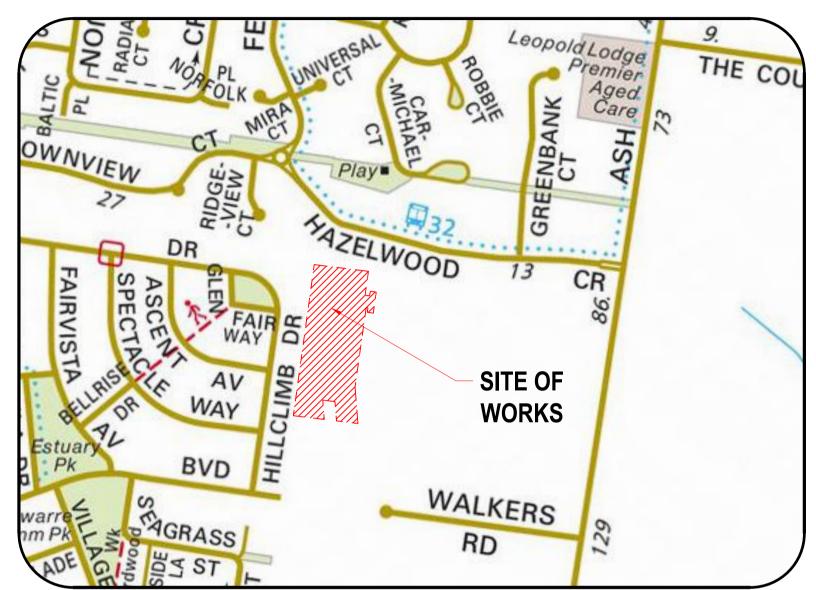

LOCALITY PLAN MELWAYS REF: 685 H3

GENERAL NOTES

- THE CONTRACTOR MUST NOTIFY THE RELEVANT AUTHORITY 7 DAYS PRIOR TO COMMENCEMENT OF
- THE CONTRACTOR MUST OBTAIN ALL NECESSARY PERMITS FROM THE MUNICIPALITY & VICROADS FOR ANY WORKS UNDERTAKEN WITHIN AN EXISTING ROAD RESERVE PRIOR TO THE COMMENCEMENT OF
- THE CONSULTANT HAS MADE EVERY REASONABLE ATTEMPT TO LOCATE EXISTING SERVICES AND HAS SITE MANAGEMENT DURING CONSTRUCTION SHOWN THESE ON THE DRAWINGS. THE CONTRACTOR SHALL TAKE PHOTOGRAPHS AND PROVIDE A ARE INTERFACING WITH, OR OTHERWISE HAVING AN IMPACT ON.
- PRIOR TO COMMENCING WORKS THE CONTRACTOR SHALL VERIFY THE LOCATION OF ALL SERVICES BY SITE SURVEY (INSPECTION AND CONSULTATION WITH ALL RELEVANT SERVICING AUTHORITIES). THE 15. ALL WORKS SHALL BE CONSTRUCTED IN ACCORDANCE WITH THE INFRASTRUCTURE DESIGN MANUAL CONTRACTOR SHALL BE RESPONSIBLE FOR ANY DAMAGE TO EXISTING SERVICES, WHETHER SHOWN OR
- THE CONTRACTOR MUST CONTACT DIAL BEFORE YOU DIG (CALL 1100), OR VISIT THE DIAL BEFORE YOU DIG WEBSITE PRIOR TO COMMENCING WORKS AND SATISFY THEMSELVES THAT THERE ARE NO SERVICES₁₆. ALL WORKS MUST ABIDE BY THE APPROVED CONSTRUCTION MANAGEMENT PLAN AND MUST COMPLY WITHIN THE VICINITY OF THE WORK AREA.
- NO WORK IS TO COMMENCE BEFORE THE CONTRACTOR HAS ASCERTAINED WHAT UNDERGROUND
- SERVICES ARE PRESENT
- CONTRACTOR MUST FOLLOW THE "NO GO ZONE" SAFETY PROCEDURES AT ALL TIMES, WHICH ARE AVAILABLE FROM ALL UTILITY AND TELECOMMUNICATIONS COMPANIES, INCLUDING THE OFFICE OF THE CHIEF ELECTRICAL INSPECTOR, THE OFFICE OF GAS SAFETY AND WORKSAFE VICTORIA.
- IF THESE SAFETY PROCEDURES CANNOT BE COMPLIED WITH THEN NO WORK IS TO BE UNDERTAKEN WITHOUT PERMISSION FROM THE UTILITY COMPANY.
- THE CONTRACTOR MUST PREPARE A PROJECT MANAGEMENT PLAN (OTHERWISE CALLED A CONSTRUCTION OR SITE MANAGEMENT PLAN) AND HAVE IT APPROVED BY BOTH COUNCIL & THE SUPERINTENDENT PRIOR TO THE COMMENCEMENT OF ANY WORKS. THIS PROJECT MANAGEMENT PLAN IS TO INCORPORATE THE FOLLOWING AT A MINIMUM AND IN ACCORDANCE WITH ANY LEGISLATION
- a. OCCUPATIONAL HEALTH & SAFETY PROCEDURES
- b. SITE STAFFING INCLUDING CONTACT DETAILS c. TRAFFIC MANAGEMENT PLAN
- d. ENVIRONMENTAL MANAGEMENT PLAN
- e. QUALITY ASSURANCE DETAILS (FOR QA CERTIFIED CONTRACTORS)
- f. CONSTRUCTION PROGRAM

CONSTRUCTION SETOUT

- 10. ALL LEVELS ARE TO A.H.D. AND ARE REFERENCED TO THE T.B.M. INDICATED.
- 11. COORDINATION OF THIS DESIGN USES MGA 94, CORRECT AS OF THE DATE OF THESE PLANS. FROM 1ST 23. AT THE COMPLETION OF WORKS ALL RUBBISH, DEBRIS AND SURPLUS SPOIL IS TO BE REMOVED AND ALL JANUARY 2017, MGA 2020 MAY BE IN STANDARD USE AND WILL DIFFER IN POSITION BY AROUND 1.8 METRES FROM THIS DOCUMENT.

- 13. IF USING GNSS \ GPS TO SETOUT FOR CONSTRUCTION PLEASE NOTE
- a. GNSS HAS REDUCED VERTICAL PRECISION COMPARED TO TRADITIONAL SURVEY METHODS. b. ONLY USE A SINGLE POINT CALIBRATION FOR THE VERTICAL THEN TEST TO AT LEAST 1 OTHER
- STATED TBM BEFORE PROCEEDING. c. IF YOU HAVE ANY QUERIES OR CONCERNS CONTACT THE CONSULTING SURVEYOR.

INCLUDING COMPLIANCE CODES.

MUNICIPAL ENGINEERING DEPARTMENT.

- WRITTEN REPORT DETAILING THE CONDITION REGARDING ALL EXISTING INFRASTRUCTURE WHICH THEY 14. THE SUPERINTENDENT IS RESPONSIBLE FOR THE DESIGN AND MANAGEMENT OF THE CONSTRUCTION WORKS. ANY PROBLEMS ARISING DURING CONSTRUCTION SHALL BE DIRECTED TO THE
 - AND ANY OTHER RELEVANT AUTHORITY SPECIFICATIONS. A COPY OF THE IDM CAN BE FOUND AT WWW.DESIGNMANUAL.COM.AU - IF YOU HAVE ANY ISSUES INTERPRETING THE MANUAL CONTACT THE SUPERINTENDENT.
 - WITH THE RECOMMENDATIONS OF THE ENVIRONMENT PROTECTION AUTHORITY PUBLICATION "CONSTRUCTION TECHNIQUES FOR SEDIMENT POLLUTION CONTROL" (PUBLICATION NO 275). APPROPRIATE SILTATION CONTROL IS TO BE CARRIED OUT DURING THE CONSTRUCTION AND MAINTENANCE PERIOD.
 - 17. BEFORE COMMENCING ANY EXCAVATION WORKS OF 1.5m DEPTH OR GREATER. THE CONTRACTOR IS 30. THE SUPERINTENDENT IS TO BE ADVISED OF ANY FILLING THAT ACHIEVES A DEPTH OF 300mm OR REQUIRED TO SUBMIT THE REQUIRED NOTIFICATION TO WORKSAFE VICTORIA. THE NOTIFICATION MUST BE RECEIVED BY THE AUTHORITY AT LEAST 3 DAYS PRIOR TO COMMENCING EXCAVATIONS. A COPY OF WITH THE MINES ACT, OCCUPATIONAL HEATH AND SAFETY ACT, WORKSAFE VICTORIA REQUIREMENTS
 - 18. TWENTY-FOUR (24) HOURS NOTIFICATION TO INSPECTORS OF RELEVANT AUTHORITY IS REQUIRED PRIOR TO AN INSPECTION BEING CONDUCTED ON ANY PARTICULAR PORTION OF THE WORKS.
 - THE CONTRACTOR SHALL TAKE THE UTMOST CARE TO PRESERVE EXISTING TREES. NO TREES SHALL BE REMOVED WITHOUT THE PRIOR APPROVAL OF THE SUPERINTENDENT.
 - EASEMENTS. ANY DAMAGE CAUSED TO THE ALLOTMENTS MUST BE MADE GOOD. 21. THE CONTRACTOR SHALL TO THE SATISFACTION OF THE SUPERINTENDENT AND COUNCIL'S SUPERVISING34. ALL LOTS ARE TO ACHIEVE A MINIMUM CROSS FALL OF 1 IN 150 (0.67%) TO A LEGAL POINT OF DISCHARGE 53. STORMWATER DRAINS SHALL BE RCP OR HDPE (PER IDM CL16.10) UNLESS OTHERWISE SHOWN.

20. THE CONTRACTOR IS REQUIRED TO CONFINE CONSTRUCTION VEHICLES TO THE ROAD RESERVE AND

COMPLY WITH THE REQUIREMENTS OF THE ROAD MANAGEMENT ACT. 22. DISPOSAL OF EXCESS SPOIL TRUCK ROUTE AND DISPOSAL LOCATION ARE TO BE APPROVED BY THE

OFFICER PROVIDE AND MAINTAIN ALL NECESSARY WARNING SIGNAGE, LIGHTING AND BARRICADING TO

LOTS AND ROAD RESERVE TO BE LEFT IN A TIDY CONDITION TO THE SATISFACTION OF THE SUPERINTENDENT & RELEVANT AUTHORITY.

THE CONSULTING SURVEYOR IS TO BE NOTIFIED OF ANY DISCREPANCIES IMMEDIATELY. TITLE PEGS AND 24. NO WORKS ARE TO BE UNDERTAKEN WITHIN THE DRIP ZONE (CANOPY) OF AN EXISTING TREE UNLESS APPROVED BY THE RESPONSIBLE AUTHORITY

25. MACHINERY IS NOT TO BE DRIVEN OVER OR PARKED WITHIN THE DRIP ZONE OF ANY TREE.

EARTHWORKS

- 26. ALL EARTHWORKS ARE TO BE UNDERTAKEN IN ACCORDANCE WITH AS 3798 (2007) GUIDELINES ON 42. ALL NEW INTERSECTIONS ARE TO HAVE STREET SIGNS INSTALLED TO COUNCIL STANDARDS EARTHWORKS FOR COMMERCIAL AND RESIDENTIAL DEVELOPMENTS.
- 27. ALL FILLING WITHIN AREAS OF PROPOSED ROAD PAVEMENT IS TO ACHIEVE A MINIMUM COMPACTION OF 43. AT ALL TEMPORARY STAGE BOUNDARY TERMINATIONS TO ROADS THE CONTRACTOR IS TO INSTALL A 98% STANDARD.
- 28. ALL FILLING WITHIN OTHER AREAS IS TO ACHIEVE A MINIMUM COMPACTION OF 95% STANDARD.
- 29. ANY FILLING IN EXCESS OF 300mm DEPTH IS TO BE CARRIED OUT UNDER LEVEL 1 SUPERVISION UNLESS DIRECTED OTHERWISE. FILL AREAS ARE TO BE STRIPPED OF TOPSOIL & FILLED USING APPROVED CLAY FILL. TOPSOIL IS TO BE REPLACED NO MORE THAN 150mm THICK TO OBTAIN FINAL FILL LEVELS AS SHOWN ACCORDANCE WITH AS3798-1996 ("GUIDELINES ON EARTHWORKS FOR COMMERCIAL AND RESIDENTIAL DEVELOPMENTS"). ON COMPLETION THE CONTRACTOR SHALL PRESENT A "LEVEL 1" TYPED REPORT NOMINATING THE EXTENT OF FILL PLACED, IT'S CONFORMANCE WITH THE SPECIFICATION AND ITS CLASSIFICATION AS "CONTROLLED FILL". IF ANY SUBSTANDARD FILLING IS ENCOUNTERED ON THE SITE IT MUST BE REMOVED AND REPLACED WITH VERIFICATION PROVIDED TO THE SUPERVISING ENGINEER. A 47. ALL SEWER MANHOLES ARE TO BE POSITIONED AND ROTATED SO THAT THEY ARE PLACED CENTRALLY GEO-TECHNICAL REPORT MUST BE SUBMITTED SHOWING DETAILS OF DEPTH, TYPE OF MATERIAL AND DENSITY OF THE FILL AREAS CONCERNED.
- THE NOTIFICATION IS TO BE PROVIDED TO THE SUPERINTENDENT. THE CONTRACTOR SHALL COMPLY 31. THE CONTRACTOR IS RESPONSIBLE FOR ENSURING THAT ALL IMPORTED FILL MATERIAL, INCLUDING TOPSOIL, SATISFIES THE DESCRIPTION FOR CLEAN FILL MATERIAL IN EPA BULLETIN PUBLICATION NO. 448 (SEPT '95) AND SUBSEQUENT REVISIONS. THE CONTRACTOR SHALL PROVIDE VERIFICATION INCLUDING TEST CERTIFICATES TO THE SUPERVISING ENGINEER.
 - 32. ALL TRENCHES ARE TO ACHIEVE THE SPECIFIED COMPACTION RESULTS WITHOUT EXCEPTION. THE SUPERINTENDENT RESERVES THE RIGHT TO REQUIRE COMPACTION TESTING BY A NATA APPROVED LABORATORY AT THE CONTRACTORS EXPENSE.
 - 33. ALL EXCAVATIONS OF DEPTH 1.5m OR GREATER MUST COMPLY WITH LEGISLATION ENFORCED BY WORKSAFE VICTORIA. A "NOTICE OF INTENTION TO COMMENCE EXCAVATION" MUST BE SUBMITTED TO 52. REFER TO THE CERTIFIED PLAN OF SUBDIVISION FOR ALL EASEMENT WIDTHS, DO NOT SCALE FROM YOUR LOCAL WORKSAFE OFFICE.
 - (DRAINAGE POINT OR ROAD RESERVE) UNLESS STATED OTHERWISE.
 - 35. RESERVES TO BE FREE DRAINING AND TO BE LEFT IN A CONDITION SATISFACTORY TO THE SUPERINTENDENT.
 - 36. ALL DISTURBED/EXPOSED AREAS MUST BE HYDROMULCHED AT THE COMPLETION OF WORKS.

ROAD WORKS AND FOOTPATHS

37. ALL KERB & CHANNEL IS B2 (IDM SD100) UNLESS STATED OTHERWISE.

— — ■ EXISTING WATER MAIN. FIRE PLUG AND VALVE PROPOSED ELECTRICITY MAIN EXISTING ELECTRICITY MAIN & PIT PROPOSED GAS MAIN EXISTING GAS MAIN PROPOSED FUTURE GAS PROPOSED TELECO MAIN EXISTING TELECO CABLE

LEGEND

PROPOSED SEWER AND MANHOLE

FILL ABOVE 300mm ALLOWING FOR 200mm STRIPPING

PROPOSED CONCRETE FOOTPATH / DRIVEWA'

PROPOSED NATURESTRIP \ LANDSCAPING PROPOSED LOT EARTHWORKS NO TOPSOIL

PROPOSED SEALED PAVEMENT

PROPOSED ASPHALT FOOTPATH PROPOSED ALTERNATE PAVEMENT

PROPOSED CRUSHED ROCK

PROPOSED KERB

PROPOSED OTHER

PROPOSED ROCK BEACHING

PROPOSED FUTURE TELECO PROPOSED CATCH DRAIN PROPOSED AG DRAIN EDGE OF SEAL / EDGE OF BITUMEN (DESIGN \ EXISTING

PROPOSED TITLE BOUNDARY & SITE TITLE BOUNDARY

EXISTING SHRUBS / TREES

ELECTRICITY LIGHT & POL

TELCO PILLAR

PROPOSED GAS & WATER CONDUI **OVERLAND 1% AEP STORMWATER FLOWPATH**

ES 101.95 EXISTING/NATURAL SURFACE LEVE FS 101.95 FINISHED SURFACE LEVEL B 101.95 PROPOSED BATTER LEVEL

DIRECTION OF LOT GRADING

PROPOSED FLAT TOP SPEED HUMI

PERMANENT SURVEY MARK △ SURVEY STATION

4-56 LEATHER ST. BREAKWATER VIC 321

AS-CONSTRUCTED SIGNATURES

PER THE IDM SD205 STANDARD DRAWINGS AND IN ACCORDANCE WITH COGG DESIGN NOTE 12

TGSIs WHERE REQUIRED ARE TO BE INSTALLED IN ACCORDANCE WITH COGG DESIGN NOTE 11.

IRRESPECTIVE OF WHETHER THEY ARE DETAILED ON THE ENGINEERING PLANS OR NOT.

D4-5 HAZARD SIGN.

44. ALL CONCRETE TO COMPLY WITH CITY OF GREATER GEELONG'S DESIGN NOTE No 12 ISSUED NOVEMBER CHANNEL IS TO HAVE A MINIMUM STRENGTH OF 280KG/M3 (28MPa), WITH FINISHES AS OUTLINED IN THE **DESIGN NOTE**

ON PLANS. ALL FILLING TO BE CARRIED OUT IN 150mm LAYERS AND COMPACTED AS DETAILED ABOVE IN 45. TRANSITIONS BETWEEN DIFFERENT KERB TYPES TO BE OVER 3.0m MINIMUM, IF IT CANNOT BE ACHIEVED CONSTRUCTION HOLD POINTS AT A PRAM CROSSING OR DRIVEWAY CROSSOVER.

ROAD PAVEMENT COMPACTION & TESTING REQUIREMENTS ARE AS PER THE IDM.

WITHIN THE FOOTPATH, TO PREVENT CRACKING.

STORMWATER DRAINAGE AND SERVICE CONDUIT NOTES

- 48. ALL EASEMENT DRAINAGE PIPES ARE 1.0m OFFSET TITLE BOUNDARY UNLESS DIMENSIONED OTHERWISE.
- 49. ALL EASEMENT DRAINAGE PITS ARE TO BE ARE 1.0m PAST TITLE BOUNDARY UNLESS DIMENSIONED
- 50. ALL PROPERTY DRAINAGE CONNECTIONS FROM ROAD RESERVES ARE TO ENTER THE PROPERTY 6.0m 66. IN ANY EMERGENCY IF YOU BELIEVE LIFE OR PROPERTY IS THREATENED DO NOT HESITATE TO CONTACT O/S SIDE BOUNDARY ON THE LOW SIDE WITH 0.5m COVER UNLESS NOTED OTHERWISE.
- 51. ALL STORMWATER AND CONDUIT TRENCHES UNDER ROAD PAVEMENT, KERB & CHANNEL AND FOOTPATH OR DIRECT OUT OF PIT SHALL BE BACKFILLED IN ACCORDANCE WITH THE IDM UNLESS STATED
- DRAWING.
- 54. RCP STORMWATER DRAINS SHALL BE CLASS 2 (RRJ) UNLESS NOTED OTHERWISE OR AGREED UPON BY THE SUPERINTENDENT. PIPE JOINTING UP TO AND INCLUDING 600mm TO BE SPIGOT & SOCKET. PIPE [DIAMETERS GREATER THAN 600mm SHALL BE FLUSH JOINTED WITH INTERIOR MORTAR JOINTS.
- 55. ALL PROPOSED DRAINAGE STUBS TO BE BLANKED OFF AT END OF PIPE WITH TIMBER PLANKS TO THE SATISFACTION OF THE SUPERVISING ENGINEER.
- 56. ALL CONDUIT LOCATIONS ARE TO BE STAMPED IN THE CONCRETE KERBING

DRAWING LIST DRAWING No. LOCALITY, GENERAL NOTES AND SHEET INDEX PLAN A4041D-04-RD000 **EXISTING CONDITIONS** AC1 A4041D-04-RD001 LOT DIMENSIONS PLAN AC1 A4041D-04-RD100 LAYOUT PLAN AC1 A4041D-04-RD200 AC1 A4041D-04-RD300 SIGNAGE & LINEMARKING PLAN AC1 A4041D-04-RD400 PAVEMENT PLAN A4041D-04-RD500 ROAD TYPICAL SECTIONS & DETAILS ROAD CROSS SECTIONS DELMARE DRIVE A4041D-04-RD601 ROAD CROSS SECTIONS DELMARE DRIVE (2 OF 2) AC1 A4041D-04-RD602 AC1 INTERSECTION DETAILS A4041D-04-RD700 AC1 A4041D-04-RD701 ATHENA PLACE SETOUT DETAILS AC1 A4041D-04-RD800 DRAINAGE LONGITUDINAL SECTIONS A4041D-04-RD801 A4041D-04-RD900 BULK EARTHWORKS RETAINING WALL LAYOUT PLAN A4041D-04-RD901 RETAINING WALL LONGITUDINAL SECTION AC1 AC1 RETAINING WALL LONGITUDINAL SECTION & DETAILS

		T	ABL	ΕO	F O	FFS	ETS	FOI	R SE	RVI	CES		
REET NAME	GA	AS	D۱	N	TEL	.CO	P2 P	ITS	UG E	LEC	LIGHT POLE	вок	SE
MARE DRIVE - NTH-STH	2.2m	EST	2.7m 5.7m	EST	1.80m	WST	*1.65m	EST	2.40m	WST	1.00m BOK	4.20W / 4.20E	1.0m
MARE DRIVE - EST-WST	2.2m	STH	2.7m 5.7m	STH	1.80m	NTH	*1.65m	STH	2.40m	NTH	1.0m BOK	4.20N/4.20mS	1.0m
HENA PLACE	2.1m	WST	2.7m	WST	2.7m	EST	*1.65m	EST	2.1m	EST	1.00m BOK	2.80W / 0.70E	1.0m

*DIMENSION IS TO OUTER PIT WALL. REFER TO TYPICAL DETAILS

58. ALL GRATES ARE TO BE HOT DIPPED GALVANISED

- 59. 100mm DEEP CATCH DRAINS TO BE CONSTRUCTED ALONG ALL EASEMENT DRAINAGE AND DIRECTED TO LEGAL POINT OF DISCHARGE
- 60. STEP IRONS ARE NOT TO BE INSTALLED IN ANY DRAINAGE PIT. ACCESS LIDS ARE TO BE LOCATED TO ENABLE REASONABLE ACCESS.

57. CONCRETE IS TO HAVE A MINIMUM COMPRESSIVE STRENGTH OF 32MPa AT 28 DAYS

- 61. ALL HOUSE DRAIN CONNECTIONS TO REINFORCED CONCRETE PIPES ARE TO UTILISE "CONCONECT" OR COUNCIL APPROVED EQUIVALENT PRODUCTS TO AVOID PIPE PROTRUSIONS INTO THE LARGER PIPE.
- 62. REFER ROAD LAYOUT PLANS FOR WATER & GAS ROAD SERVICE CONDUIT LOCATIONS. INTERSECTION DETAILS PLANS DO NOT SHOW CONDUITS.
- 2020. CONCRETE FOR FOOTPATHS IS TO HAVE A MINIMUM STRENGTH OF 32MPa (N32) AND KERB AND 63. ELECTRICITY & TELECOMMUNICATIONS CONDUITS SHOWN ON THESE PLANS ARE CONCEPTUAL ONLY. REFER TO ELECTRICITY & TELECOMMUNICATION PLANS FOR ACTUAL ROAD SERVICE CONDUIT LOCATIONS. IF THERE ARE ANY
 - DISCREPANCIES BETWEEN THESE PLANS CONTACT SUPERINTENDENT FOR CLARIFICATION.

64. CONSTRUCTION HOLD POINTS ARE TO BE IN ACCORDANCE WITH THE IDM

EMERGENCY CONTACTS

65. THE PROJECT AREA CONTAINS THE FOLLOWING SERVICES FOR ASSISTANCE IN EMERGENCY CONTACT

SERVICE	AUTHORITY & CONTACT	TELEPHONE
DRAINAGE	CITY OF GREATER GEELONG	5272 4608
ELECTRICITY	POWERCOR	132 206
GAS	AUSNET GAS	1800 088 208
COMMUNICATIONS	TELSTRA	1800 653 935

BARWON WATER

STATE EMERGENCY SERVICES ON TELEPHONE 000

REFER TO ELECTRICAL AND TELSTRA PLANS FOR SERVIC AND CONDUIT DETAILS

SEWER & WATER

WARNING

BEWARE OF UNDERGROUND SERVICES THE LOCATIONS OF UNDERGROUND SERVICES ARE APPROXIMATE ONLY AND THEIR EXACT POSITION SHOULD BE PROVEN ON SITE. NO GUARANTEE IS GIVEN THAT

ALL EXISTING SERVICES ARE SHOWN. **ESTUARY II - STAGE 04 PP-729-2021**

ASH ROAD, LEOPOLD ROAD AND DRAINAGE LOCALITY, GENERAL NOTES AND SHEET INDEX PLAN AUTHORITY: CITY OF GREATER GEELONG

CLIENT: ASH ROAD LEOPOLD PTY LTD PROJECT & DWG No:

AS CONTRUCTED A4041D-04-RD000

AC1 AS CONSTRUCTED MK SP MM CS 23/05/25 DRAWING LIST REVISIONS UPDATED B TITLE BLOCK UPDATED A PRELIMINARY ISSUE REVISION DES DWG CHK AUTH DATE



10 / 6-8 BOSTON STREET TORQUAY PH 03 5261 3788

ABN 11 103 336 358 WWW.TOMKINSON.COM




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AS-CONSTRUCTED SIGNATURES 10/6-8 BOSTON RD, TORQUAY 3228 23/05/25 DRAPER'S CIVIL CONTRACTING PTY LTD 54-56 LEATHER ST, BREAKWATER VIC 3219


SURVEY INFORMATION											
TYPE	LOCATION	East	North	Level							
PM 113	Moolap PM113, 834 Bellarine Hwy	278 720.123	5 769 908.950	50.178 AHD							
PM 114	Moolap PM114, Adj Rail Trail, Christies Rd	278 875.760	5 770 862.357	36.515 AHD							
PM 88	Moolap PM 88, 501 Bellarine Hwy	275 647.154	5 770 793.750	12.388 AHD							
RIVET	Concrete Path - Ash Road	278 133.433	5 768 724.731	47.016 AHD							
RIVET	Concrete Path - Ash Road	278 142.050	5 768 786.098	47.925 AHD							
RIVET	Concrete Path - Juniper Avenue	277 971.285	5 768 807.641	49.948 AHD							

MK SP MM CS 23/05/25 AC1 AS CONSTRUCTED B TITLE BLOCK UPDATED A PRELIMINARY ISSUE REVISION DES DWG CHK AUTH DATE



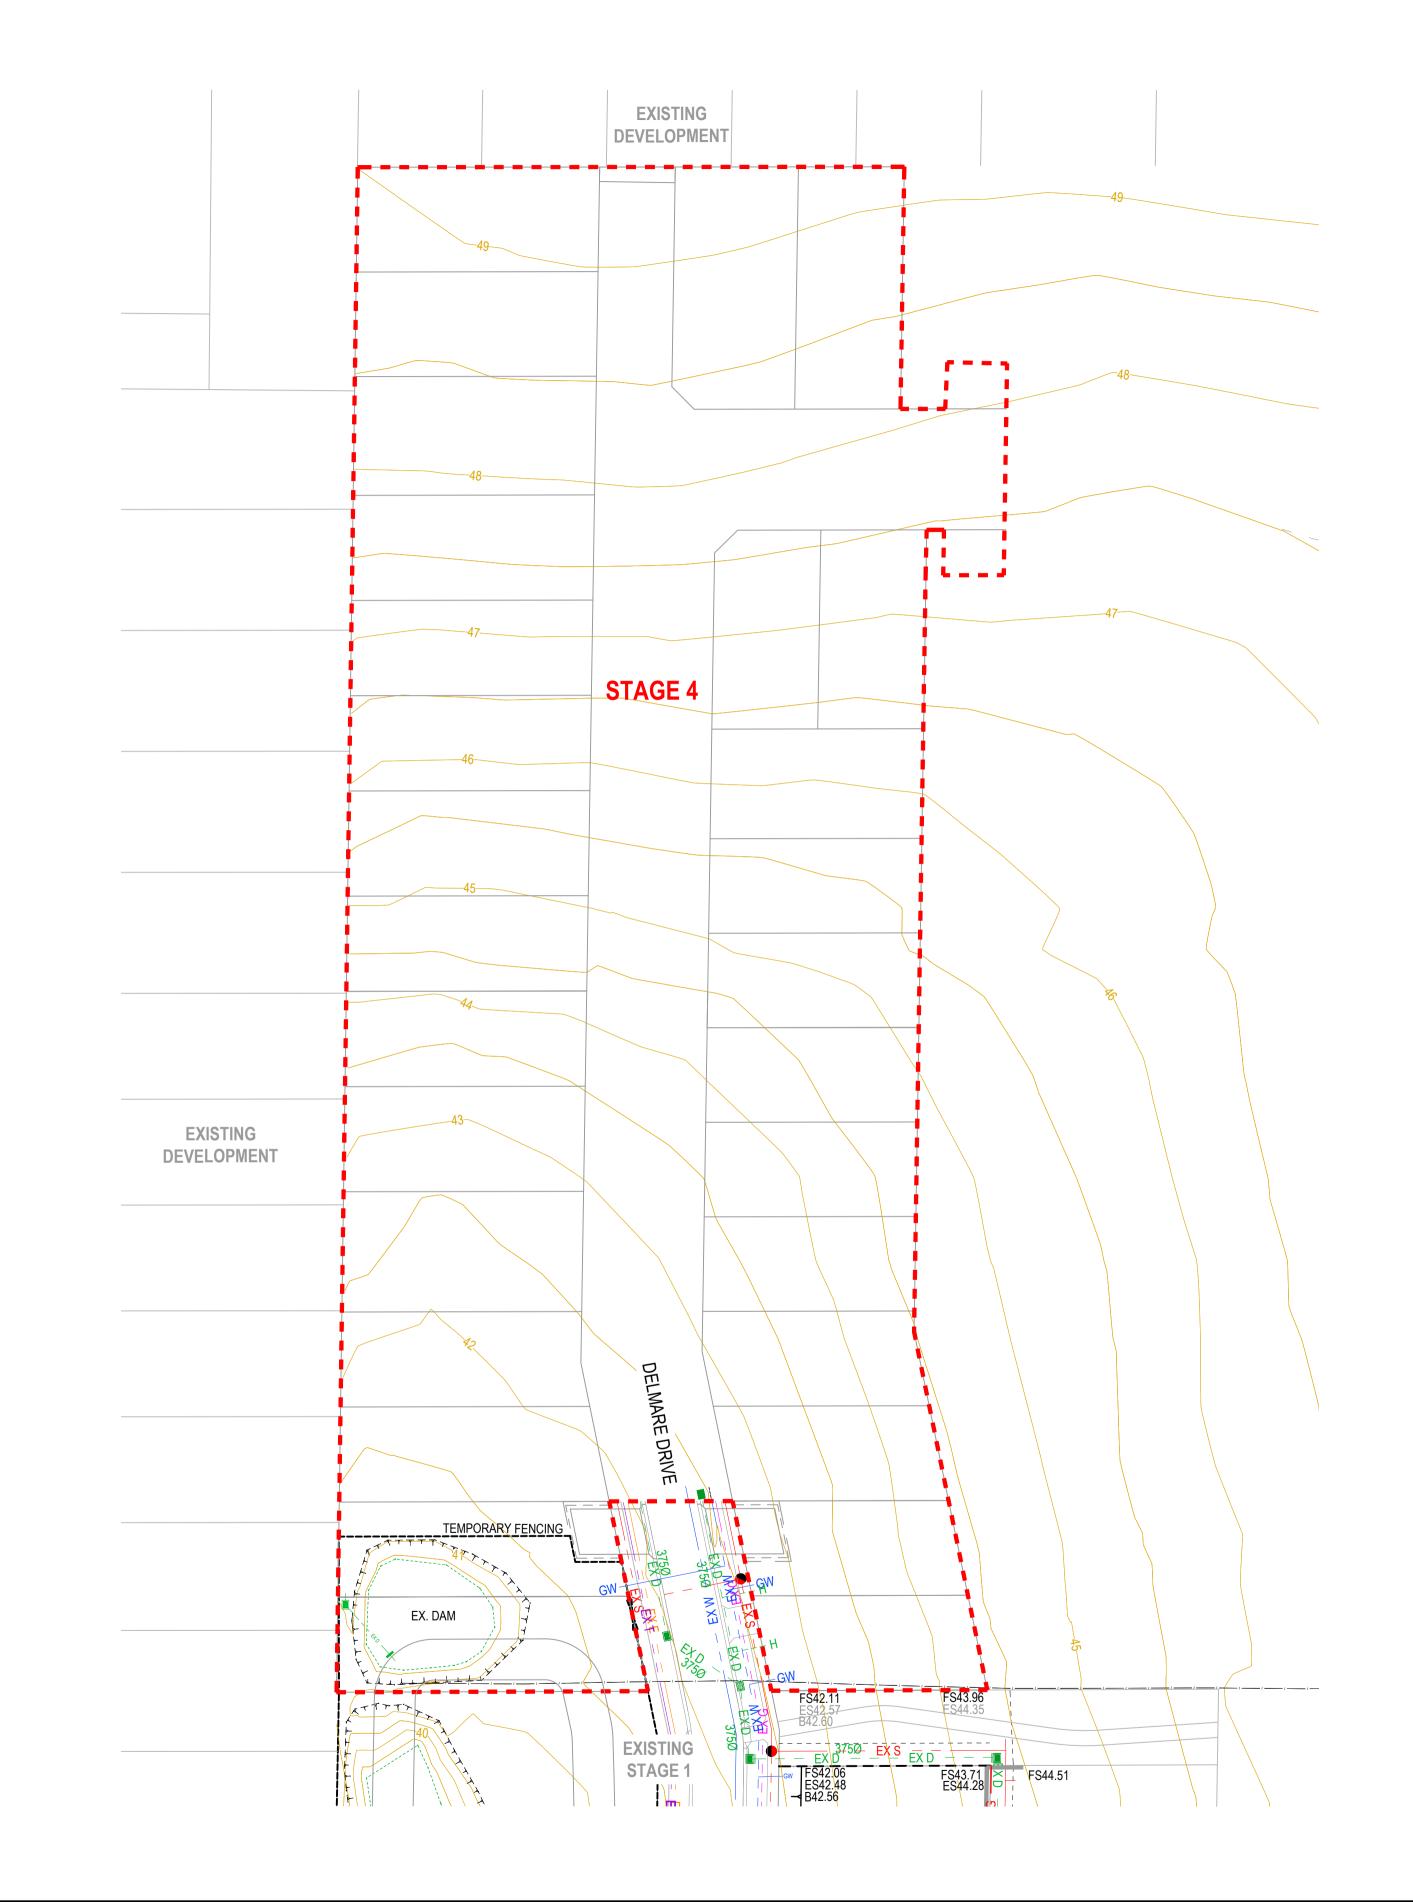



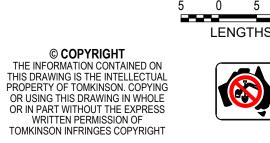






DWG STATUS: PROJECT & DWG No:

AS CONTRUCTED A4041D-04-RD001

NOTE:

REFER TO PLANS OF SUBDIVISION PS 848071W & PS 848072U FOR MORE INFORMATION

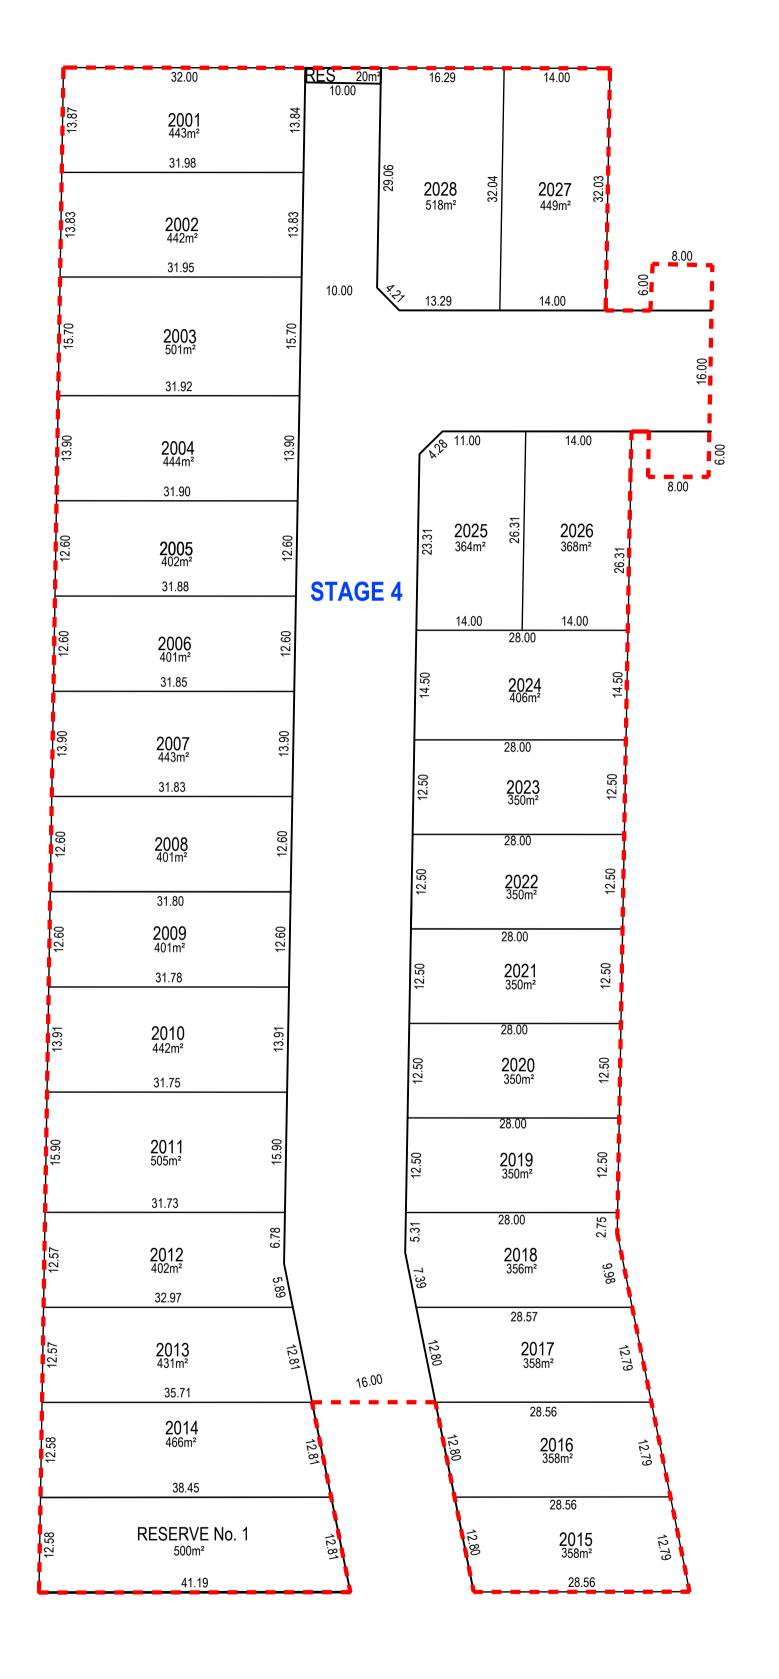

AS-CONSTRUCTED SIGNATURES 10/6-8 BOSTON RD, TORQUAY 3228 DRAPER'S CIVIL CONTRACTING PTY LTD

54-56 LEATHER ST, BREAKWATER VIC 3219

AC1 AS CONSTRUCTED MK SP MM CS 23/05/25 B TITLE BLOCK AND DRAWING NAME UPDATE A PRELIMINARY ISSUE DES DWG CHK AUTH DATE REVISION





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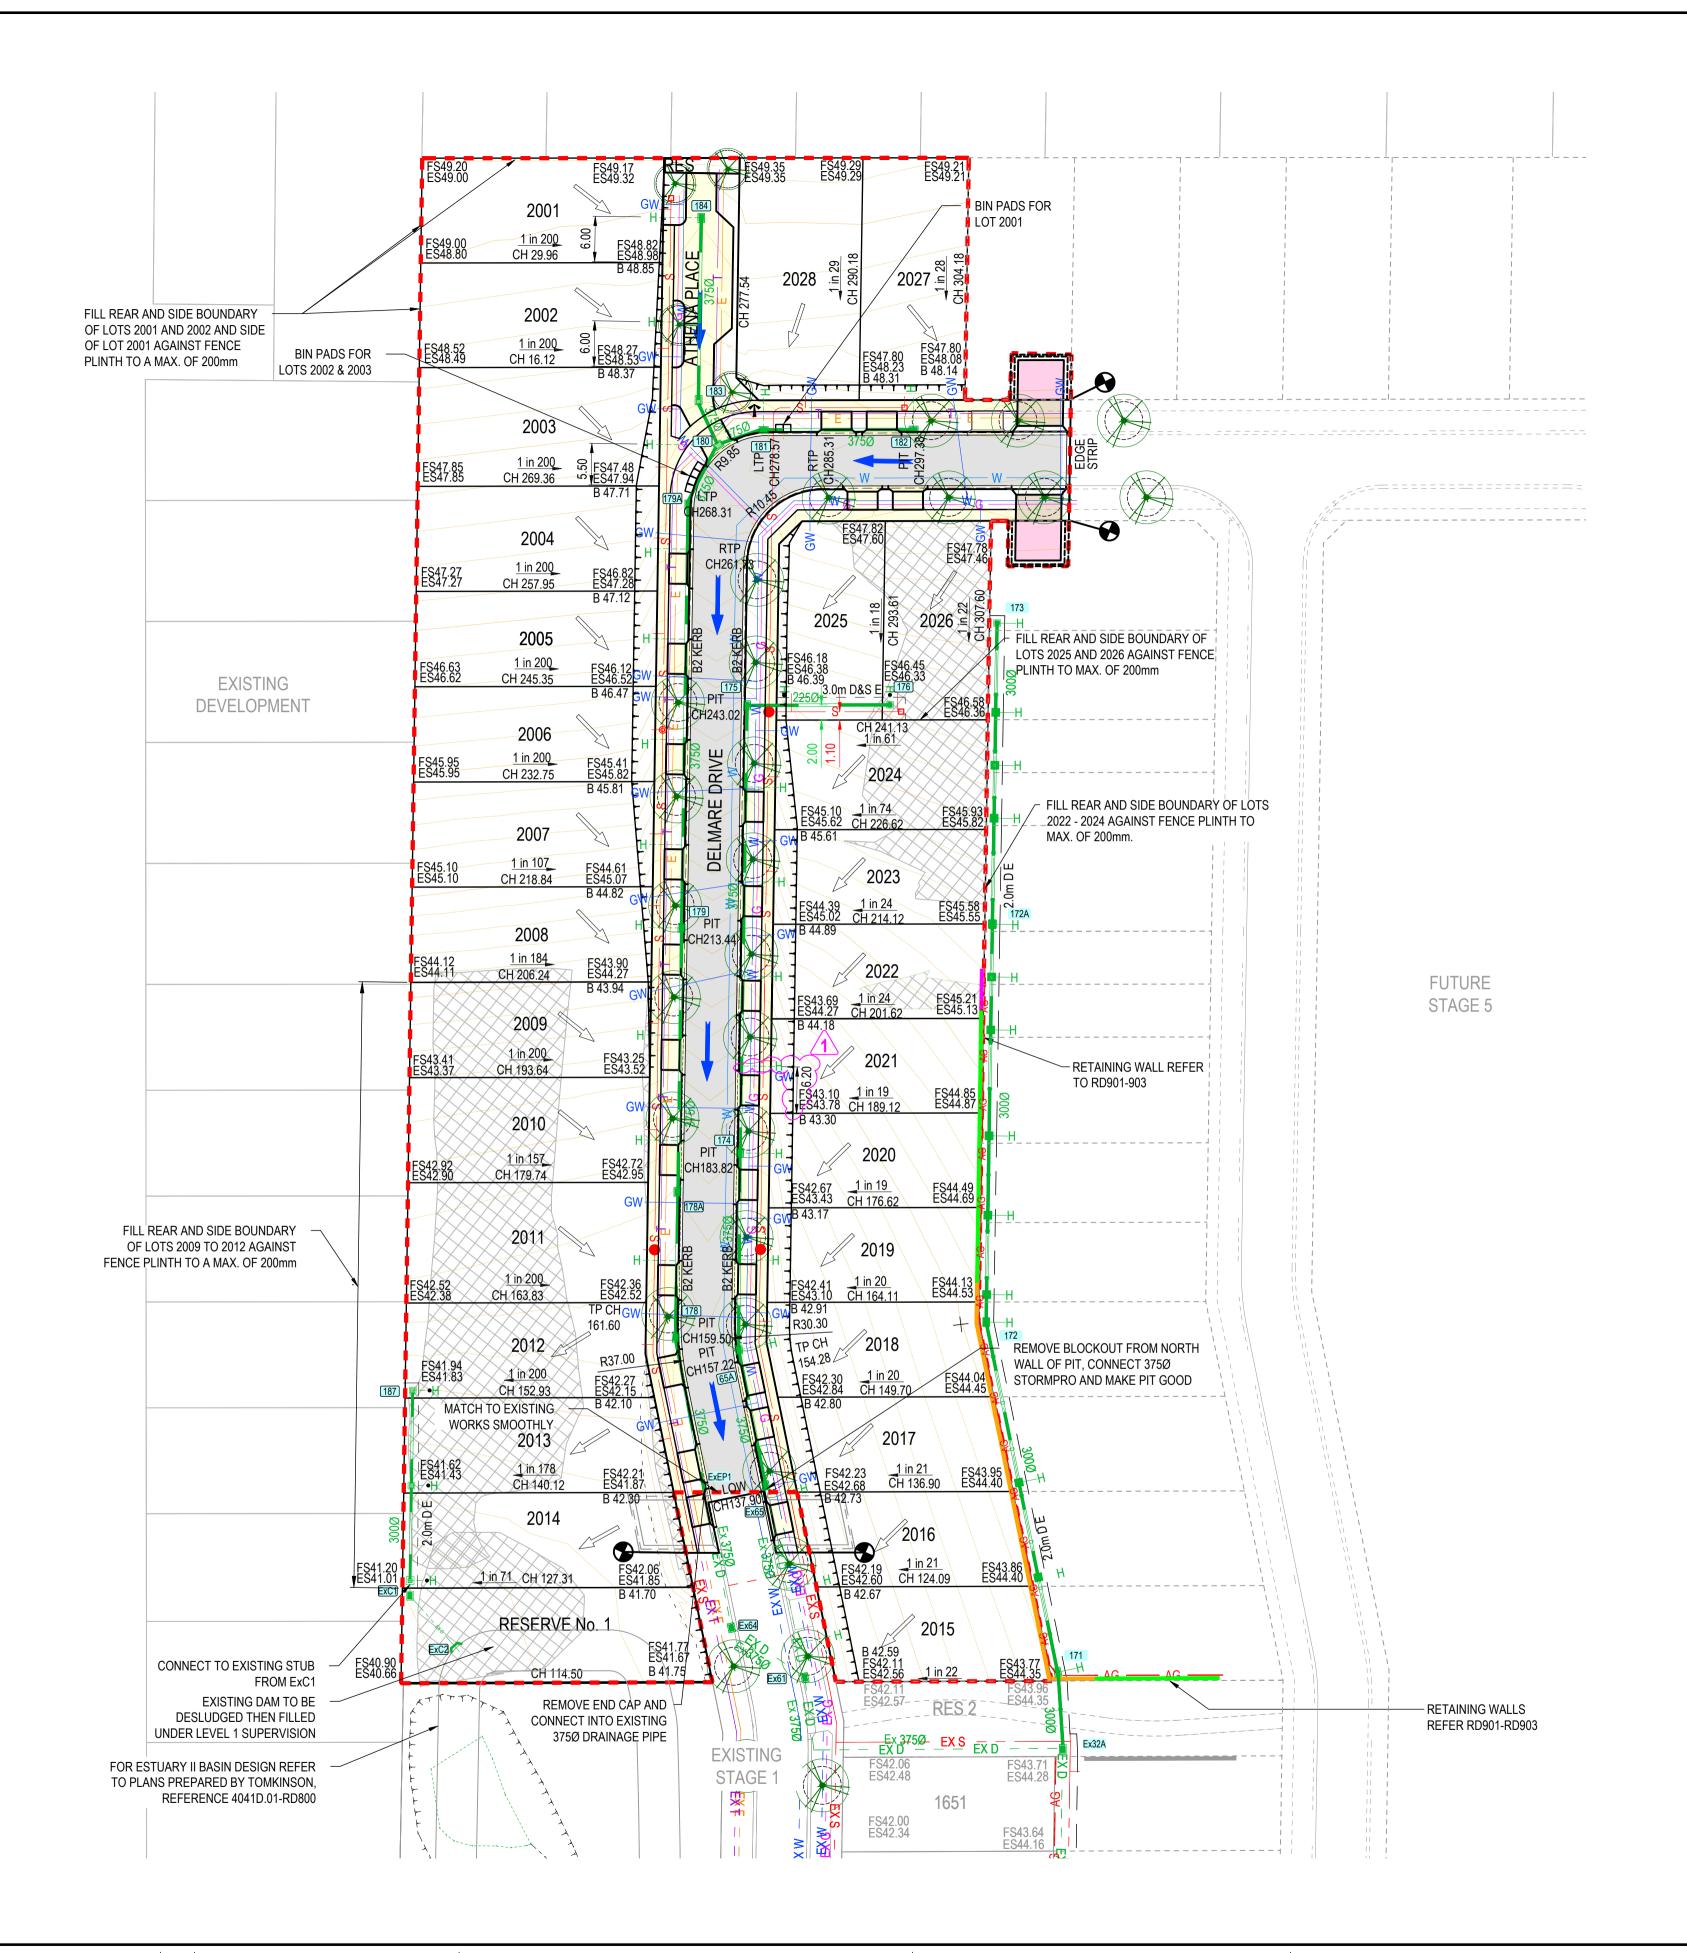


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ESTUARY II - STAGE 04 PP-729-2021 ASH ROAD, LEOPOLD ROAD AND DRAINAGE LOT DIMENSION PLAN AUTHORITY: CITY OF GREATER GEELONG CLIENT: ASH ROAD LEOPOLD PTY LTD



GENERAL DESIGN DETAIL PLAN NOTES APPLIES IN ALL CASES UNLESS STATED OTHERWISE

APPLIES IN ALL CASES UNLESS STATED OTKERB TYPES:

- •• FRONTING LOTS = 450mm B2 AS PER IDM SD 100
- ALL DRIVEWAYS AS PER COGG DESIGN NOTE 4 AND READ IN
- CONJUNCTION WITH IDM SD420

 ALL FOOTPATHS CONCRETE & 1.5m WIDE @ 0.05m O/S AS PER IDM
- ALL EASEMENT DRAINAGE PIPES & PITS ARE 1.0m O/S BL & SIDE
- BOUNDARIES
- ALL LOTS TO HAVE CATCH DRAINS ALONG SIDE & REAR BOUNDARIES
- CONTOUR INTERVAL 0.5m @ 1:1000 & 0.05m @ 1:200 / 1:250(A3)
- WHERE SHOWN

 RESERVE BOUNDARIES ADJACENT LOTS TO BE FULLY FENCED.
- REFER TO LANDSCAPING PLANS FOR DETAILS.

 REFER RD500 FOR CORNER LOT LEVELS.

WARNING

BEWARE OF UNDERGROUND SERVICES
THE LOCATIONS OF UNDERGROUND
SERVICES ARE APPROXIMATE ONLY AND
THEIR EXACT POSITION SHOULD BE PROVEN
ON SITE. NO GUARANTEE IS GIVEN THAT
ALL EXISTING SERVICES ARE SHOWN.



FILL > 300mm REQUIRES
LEVEL 1 SUPERVISION

NOTE: FILL ALLOWS FOR 200mm STRIPPING

CONTRACTOR TO REMOVE ALL TEMPORARY
TURNING AREAS, EDGE STRIPS AND AG DRAINS
INCLUDING INDUSTRIAL CROSSING. REINSTATE WITH
STANDARD COGG RESIDENTIAL CROSSING, KERB
AND NATURE STRIP TO COUNCIL SATISFACTION.

AS-CONSTRUCTED SIGNATURES

SIGN DATE

TOMKINSON GROUP

10/6-8 BOSTON RD, TORQUAY 3228

dney Glenister 23/05/25

DATE

DRAPER'S CIVIL CONTRACTING PTY LTD 54-56 LEATHER ST, BREAKWATER VIC 3219

AC1 AS CONSTRUCTED

1 RETAINING WALL LENGTH REDUCED, LOT 2020 HC OFFSET AMENDED

B TITLE BLOCK UPDATED

A PRELIMINARY ISSUE

REVISION

MGA94 ZONE 55

MK SP MM CS 23/05/25

MK MK MM CS 28/10/24

MK MK MM CS 01/10/24

DES DWG CHK AUTH DATE






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ABN 11 103 336 358 WWW.TOMKINSON.COM





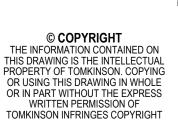



ESTUARY II - STAGE 04 PP-729-2021
ASH ROAD, LEOPOLD
ROAD AND DRAINAGE
LAYOUT PLAN
AUTHORITY: CITY OF GREATER GEELONG

CLIENT: ASH ROAD LEOPOLD PTY LTD

DWG STATUS: PROJECT & DWG I

DWG STATUS:


PROJECT & DWG No:

AS CONTRUCTED A4041D-04-RD200




STRE	STREET SIGN SCHEDULE								
SIGN	STREET NAME	QTY							
D4-5	DELMARE DR	2							
R1-2 A	ATHENA PL	1							



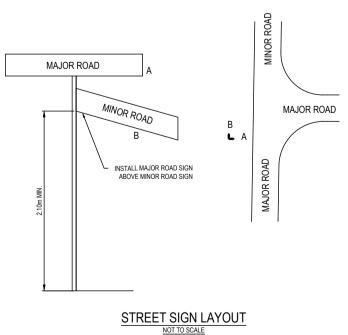


REVISION

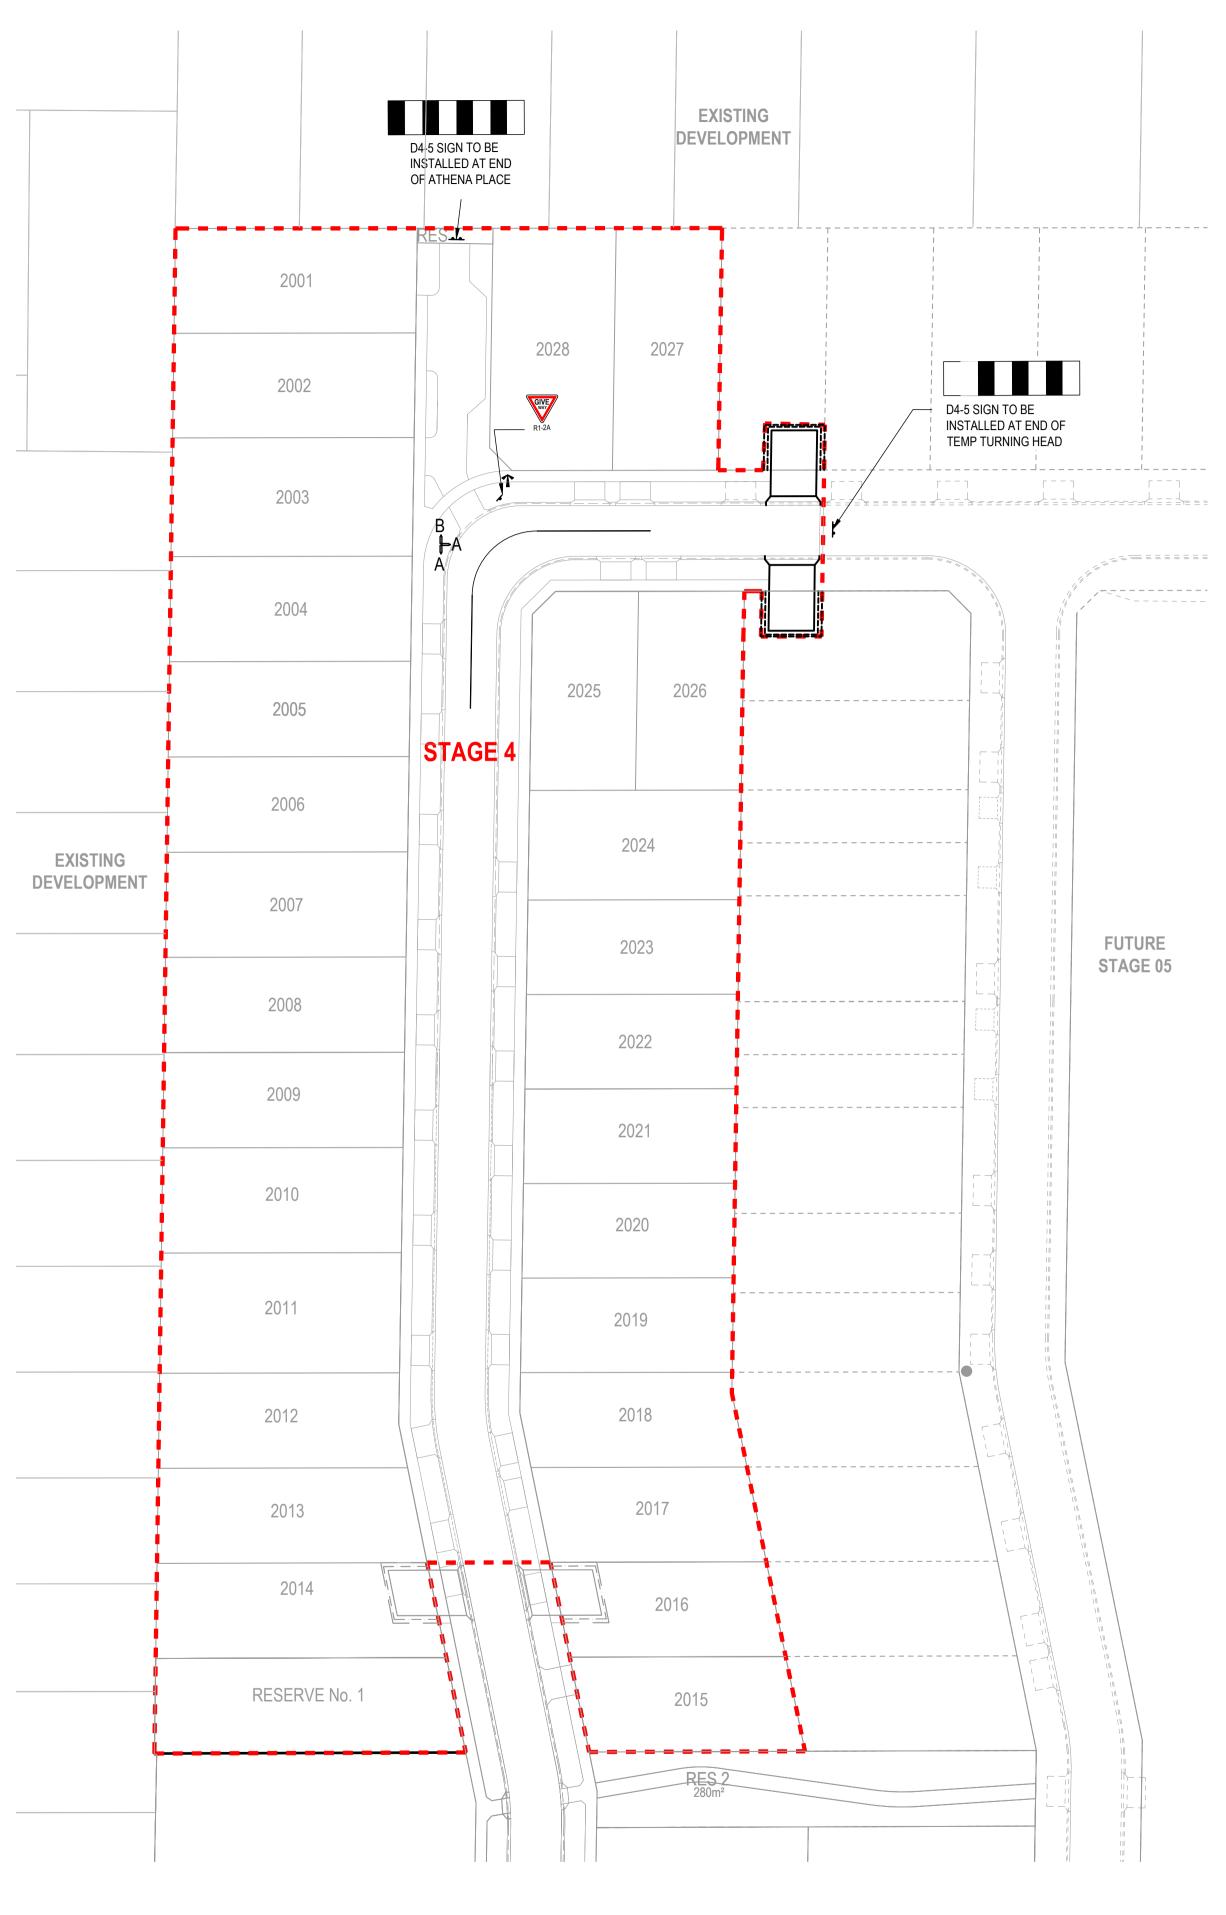

SIGNAGE & LINEMARKING NOTES:

- 90° BENDS TO HAVE CENTRE LINEMARKING WITH RRPM'S AT MAX 6m SPACING.
- RRPM'S TO BE IN ACCORDANCE WITH VICROADS TRAFFIC ENGINEERING MANUAL VOL. 2. ALL LINEMARKING AND SIGNAGE TO BE IN ACCORDANCE WITH AUSTRALIAN STANDARD AS1742.
- 4. ALL SIGNS AND LINEMARKING TO BE IN ACCORDANCE WITH VICROADS TRAFFIC ENGINEERING MANUAL VOLUME 2 - SIGNS AND LINEMARKINGS.
- ALL SIGN POSTS TO BE SLEEVED IN ACCORDANCE WITH COGG SD CGG710 SIGN POSTS.
- ALL LINEMARKINGS TO BE THERMOPLASTIC PERMANENT PAINT.
- 7. ALL HYDRANTS TO BE IDENTIFIED IN ACCORDANCE WITH C.F.A. DOCUMENT IDENTIFICATION OF STREET HYDRANTS FOR FIREFIGHTING PURPOSES, PUBLISHED JULY 2019 INCLUDING INSTALLATION OF BLUE RAISED REFLECTIVE PAVEMENT MARKERS & PAINTED WHITE REFLECTIVE

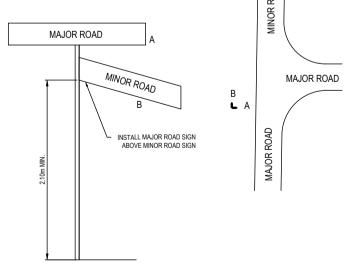

AC1 AS CONSTRUCTED

B TITLE BLOCK UPDATED

A PRELIMINARY ISSUE





MK SP MM CS 23/05/25

MK MK MM CS 01/10/24





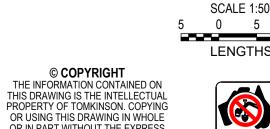

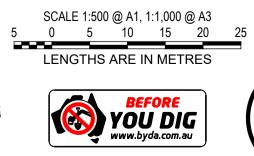



ESTUARY II - STAGE 04 PP-729-2021 ASH ROAD, LEOPOLD ROAD AND DRAINAGE SIGNAGE AND LINEMARKING PLAN AUTHORITY: CITY OF GREATER GEELONG CLIENT: ASH ROAD LEOPOLD PTY LTD

DWG STATUS: PROJECT & DWG No: AS CONTRUCTED A4041D-04-RD300

OR USING THIS DRAWING IN WHOLE OR IN PART WITHOUT THE EXPRESS WRITTEN PERMISSION OF 10 / 6-8 BOSTON STREET TORQUAY PH 03 5261 3788 TOMKINSON INFRINGES COPYRIGHT DES DWG CHK AUTH DATE ABN 11 103 336 358 WWW.TOMKINSON.COM

DELMARE DRIVE NORTH - SOUTH SECTION

490mm DEP	TH PAVEMENT	
PAVEMENT LAYER	LAYER THICKNESS (mm)	MATERIAL
1. WEARING COURSE	40	SIZE 10 TYPE N BITUMINOUS SURFACING
2. UPPER BASE COURSE	150	20mm NOM. SIZE CL 2 FCR COMPACT TO 98% MMDD
3. LOWER BASE COURSE	150	20mm NOM. SIZE CL 3 FCR COMPACT TO 98% MMDD
4. SUBBASE COURSE	150	20mm CL 4 FCR SUBGRADE IMPROVEMENT LAYER COMPACT TO 98% SMDD
5. SUBGRADE		PREPARED SUBGRADE TO 98% SMDD

DELMARE DRIVE FAST - WEST SECTION

DELIMARE DRIVE EAST -	WEST SECTION		_
560mm DE	EPTH PAVEMENT		
PAVEMENT LAYER	LAYER THICKNESS (mm)	MATERIAL	
1. WEARING COURSE	40	SIZE 10 TYPE N BITUMINOUS SURFACING	- / / /
2. UPPER BASE COURSE	150	20mm NOM. SIZE CL 2 FCR COMPACT TO 98% MMDD	
3. LOWER BASE COURSE	220	20mm NOM. SIZE CL 3 FCR COMPACT TO 98% MMDD	
4. SUBBASE COURSE	150	20mm CL 4 FCR SUBGRADE IMPROVEMENT LAYER COMPACT TO 98% SMDD	
5. SUBGRADE		PREPARED SUBGRADE TO 98% SMDD	


AND DRIVEWAY DE	TH, SHARED PATH PAVEMENT TAILS (IDM SD 205) & COGG IGN NOTE 12	
PAVEMENT LAYER	LAYER THICKNESS (mm)	MATERIAL
1 SURFACE FINISH		BROOMED FINISH & TOOLED JOINTS. FINISHED SURFACE TO COMPLY WITH AS 4586 - SLIP RESISTANT CLASSIFICATION OF NEW PEDESTRIAN SURFACE MATERIALS
2 CONCRETE	125	CONCRETE 32MPa WITH SL72 TOP REINFORCEMENT WITH 50mm MIN. COVER.
3 BASE	100	20mm NOM. SIZE CLASS 3 FINE CRUSHED ROCK (SEE NOTE C BELOW)
4 SUBGRADE		SUBGRADE PREPARATION (SEE NOTE 6 BELOW). SUBGRADE IMPROVEMENT AS DIRECTED BY SUPERINTENDENT


ATHENA PLACE

REINFORCED CO	NCRETE PAVEMENT		
PAVEMENT LAYER	LAYER THICKNESS (mm)	MATERIAL	
1 SURFACE FINISH		BROOMED FINISH & TOOLED JOINTS. FINISHED SURFACE TO COMPLY WITH AS 4586 - SLIP RESISTANT CLASSIFICATION OF NEW PEDESTRIAN SURFACE MATERIALS	
2 CONCRETE	150	JRCP REINFORCED WITH SL72 MESH. MIN STRENGTH 32MPa	
3 BASE	150	20mm NOM. SIZE 5% CTCR	
4 SUBGRADE		SUBGRADE PREPARATION (SEE NOTE 6 BELOW). SUBGRADE IMPROVEMENT AS DIRECTED BY SUPERINTENDENT	

DES DWG CHK AUTH DATE

GRAVEL	PAVEMENT	
PAVEMENT LAYER	LAYER THICKNESS (mm)	MATERIAL
1 BASE COURSE	250	20mm NOM. SIZE CLASS 2 FINE CRUSHED ROCK

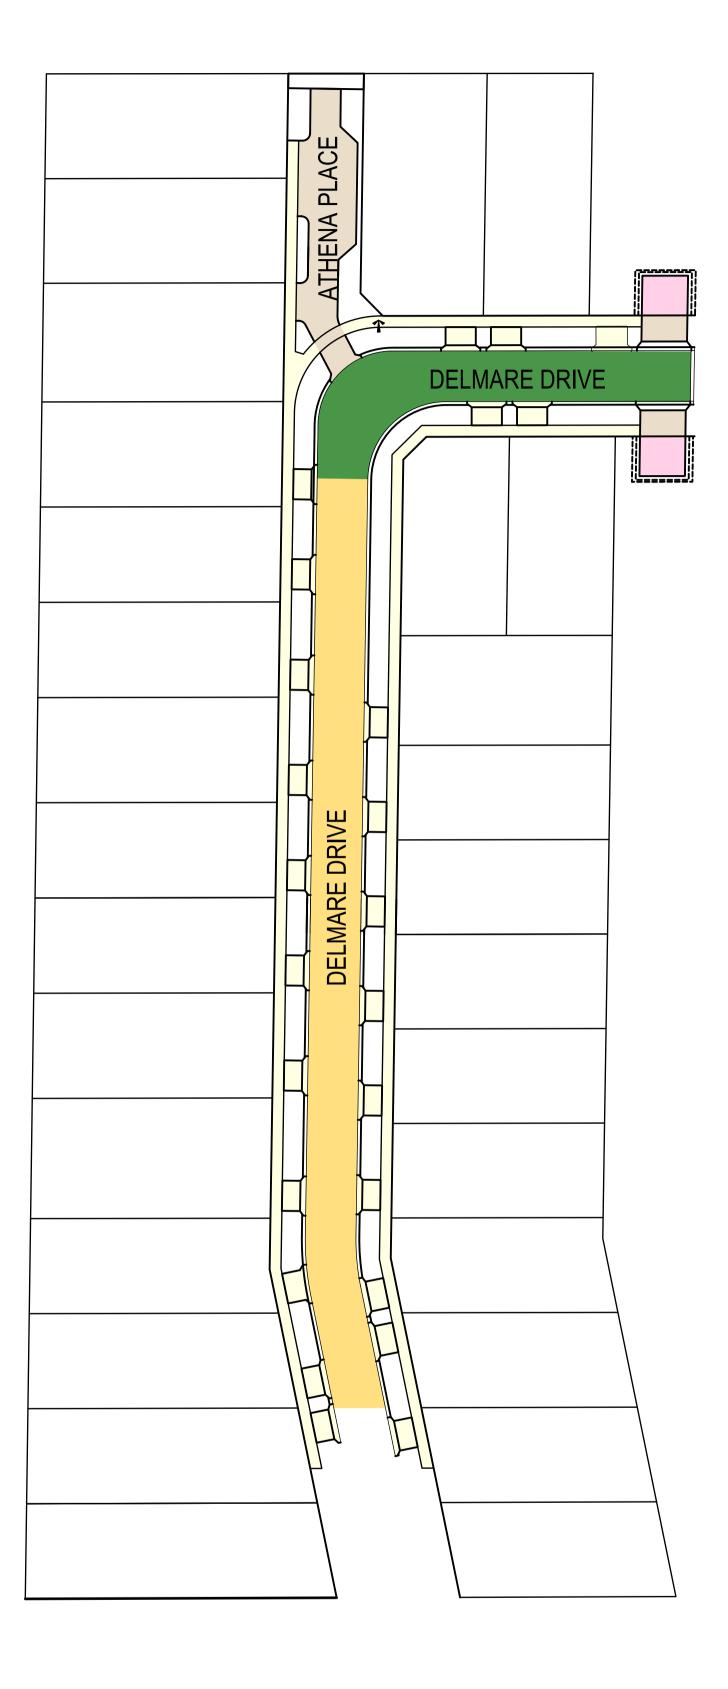

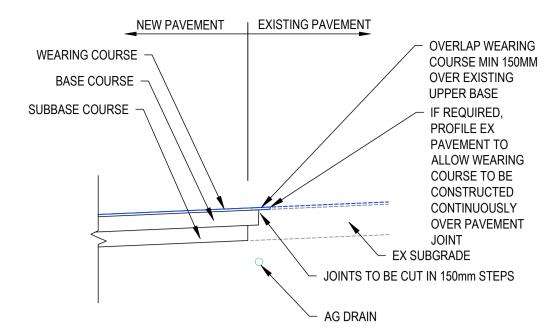

PAVEMENT CONNECTION - DETAIL

NOT TO SCALE

REFER TO GEOTECHNICAL INVESTIGATION REPORT BY GEOTEST CIVIL SERVICES DATED 7 JULY 2022 FOR ESTUARY BLVD, WALKERS ROAD, ASH ROAD, DELMARE / RHEA DRIVE, HAMA / ELDORIS AVE AND ZALE / SEDNA STREET.

AS-CONSTRUCTED SIGNATURES



PAVEMENT NOTES:

- A. ROAD PAVEMENT COMPOSITIONS TO BE AS PER GEOTECHNICAL REPORT "ESTUARY II ESTATE, 6981/22/410
- ASH ROAD LEOPOLD" PREPARED BY GEOTEST CIVIL SERVICES B. PAVEMENT BASE COURSES ARE TO BE COMPACTED TO A MINIMUM DRY DENSITY RATIO OF 98% MODIFIED

MOISTURE CONTENT WITHIN ±3% OF STANDARD OPTIMUM MOISTURE CONTENT (SOMC).

- WITH MOISTURE CONTENT WITHIN ±3% OF MODIFIED OPTIMUM MOISTURE CONTENT (MOMC). PAVEMENT SUBBASE COURSES ARE TO BE COMPACTED TO A MINIMUM DRY DENSITY RATIO OF 98% MODIFIED
- WITH MOISTURE CONTENT WITHIN ±3% OF MODIFIED OPTIMUM MOISTURE CONTENT (MOMC).
- D. THE CAPPING LAYER SHALL BE COMPACTED TO A MINIMUM DRY DENSITY RATIO OF 98% STANDARD WITH
- PAVEMENT LAYERS SHOULD BE PLACED AND COMPACTED IN LAYERS NOT EXCEEDING 200mm THICKNESS. F. SUBGRADE PREPARATION AND ENGINEERED FILL CONSTRUCTION (PAVEMENTS) TO BE IN ACCORDANCE WITH
- RELEVANT STANDARDS. G. WHEN PAVEMENT EXCAVATION IS IN ROCK, ALL LOOSE MATERIAL (INCL' ROCK & CLAY) MUST BE REMOVED.
- THE SUBGRADE MUST THEN BE REGULATED WITH COUNCIL APPROVED MATERIAL. H. PRIOR TO PLACEMENT OF THE FILL MATERIAL UNDER NEW PAVEMENT, APPROVAL OF THE MATERIAL TO BE
- USED MUST BE OBTAINED FROM COUNCIL.

I. ALL CONCRETE WORKS TO ABIDE WITH CITY OF GREATER GEELONG'S DESIGN NOTE No 12 ISSUED 2020.

AC1 AS CONSTRUCTED MK SP MM CS 23/05/25 B TITLE BLOCK UPDATED ATHENA CONCRETE STRENGTH AMENDED MK MK MM CS 01/10/24 A PRELIMINARY ISSUE

REVISION






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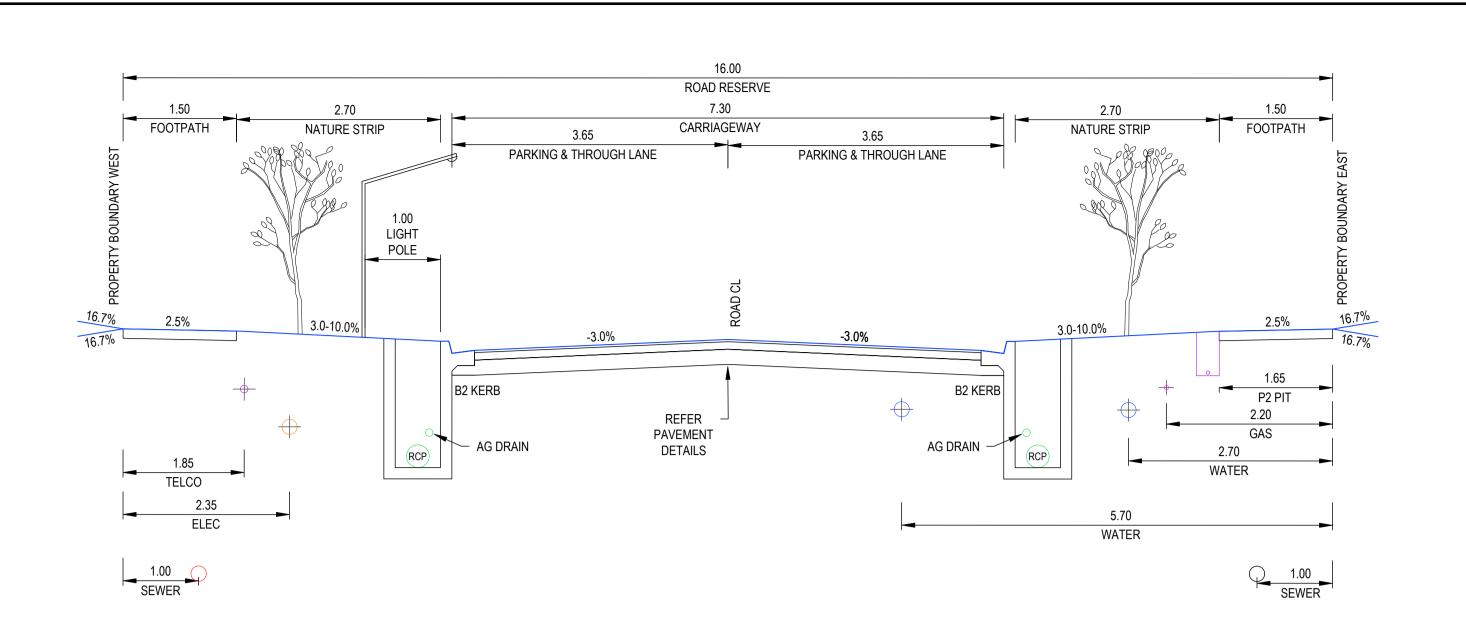





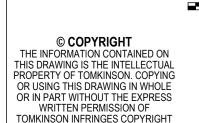

PROJECT & DWG No:

AS CONTRUCTED A4041D-04-RD400




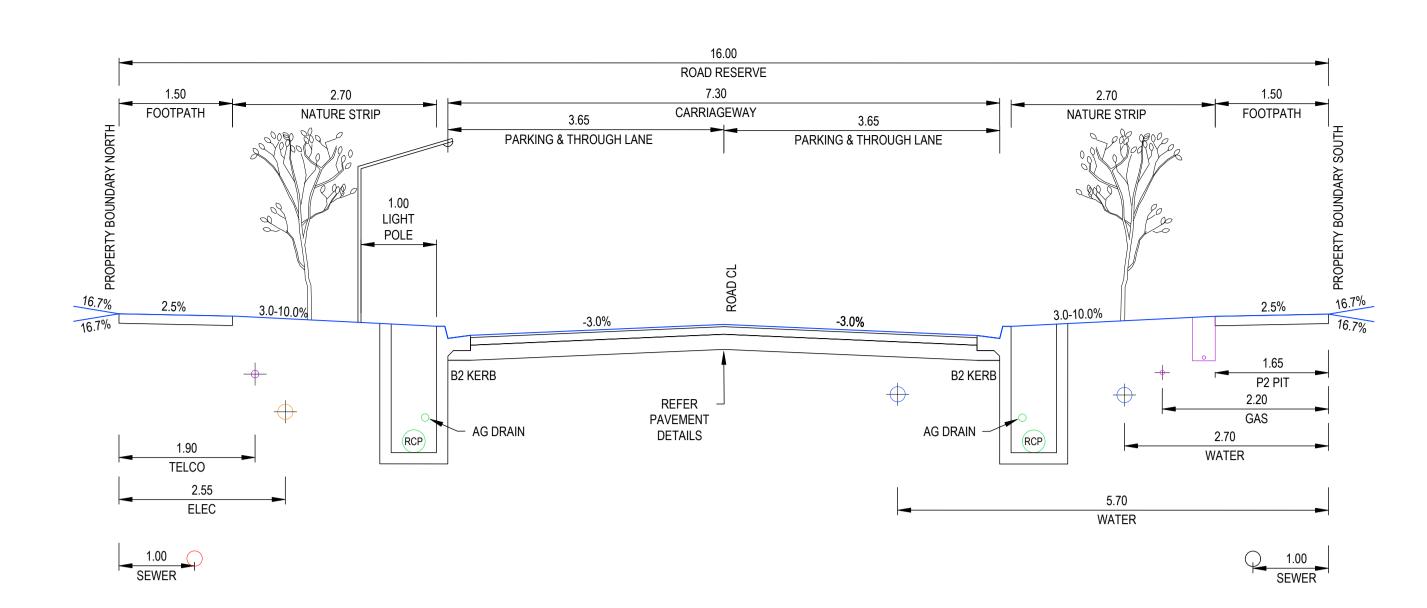



16m ROAD RESERVE - DELMARE DRIVE WEST TO EAST - TYPICAL SECTION NOT TO SCALE

16m ROAD RESERVE - DELMARE DRIVE NORTH TO SOUTH - TYPICAL SECTION NOT TO SCALE



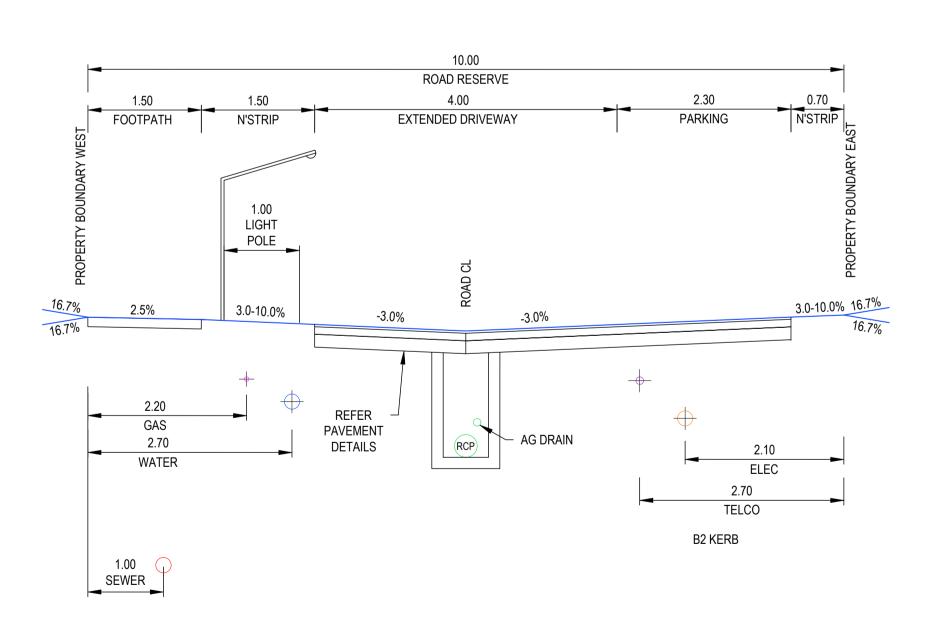

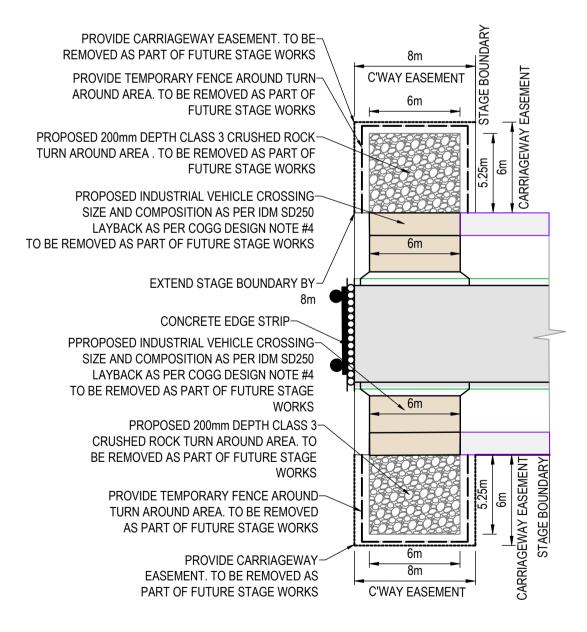


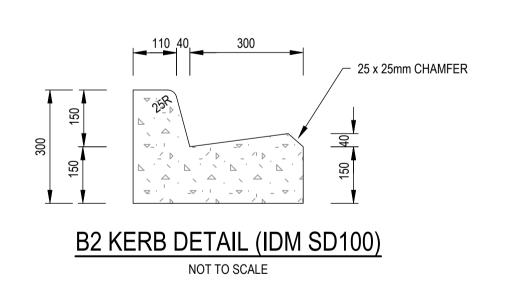


TYPICAL CARRIAGEWAY EASEMENT TURN AREA DETAIL NOT TO SCALE

10m ROAD RESERVE - ATHENA PLACE TYPICAL SECTION NOT TO SCALE

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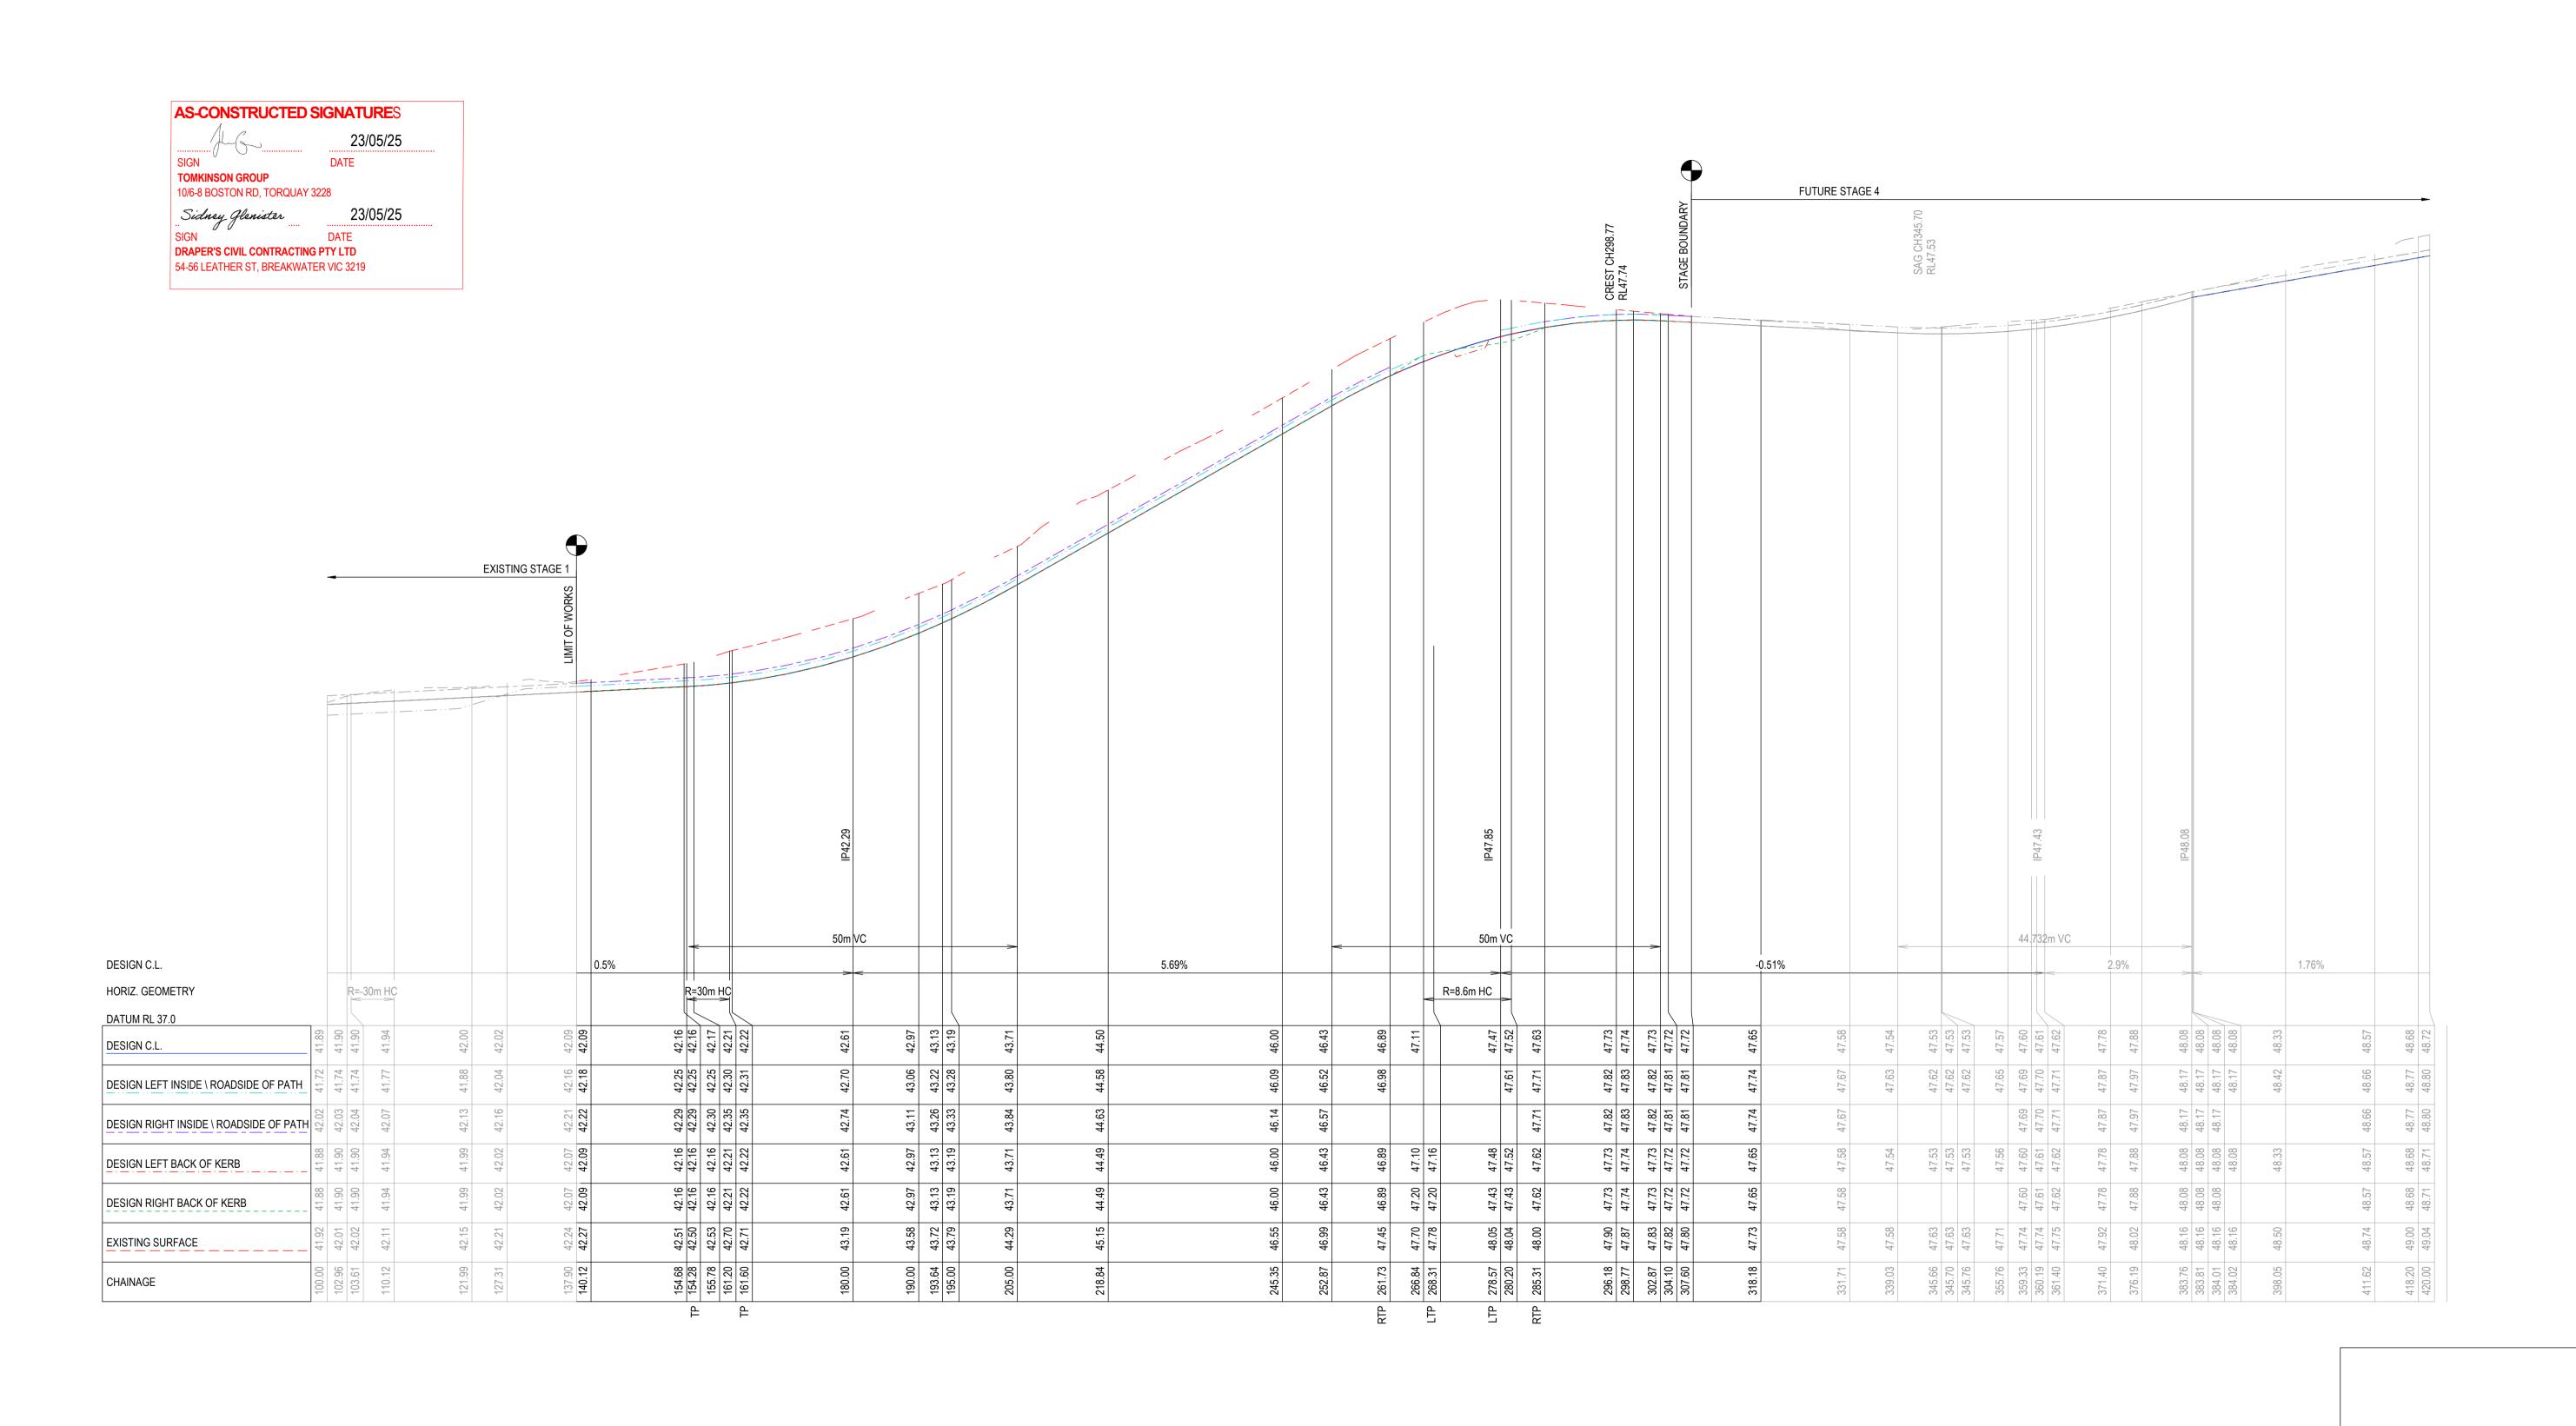
ESTUARY II - STAGE 04 PP-729-2021 ASH ROAD, LEOPOLD **ROAD AND DRAINAGE ROAD TYPICAL SECTIONS & DETAILS** AUTHORITY: CITY OF GREATER GEELONG CLIENT: ASH ROAD LEOPOLD PTY LTD

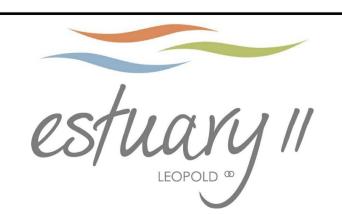AC1 AS CONSTRUCTED MK SP MM CS 23/05/25 B TITLE BLOCK UPDATED A PRELIMINARY ISSUE 16/05/24 REVISION DES DWG CHK AUTH DATE

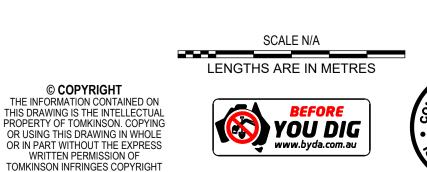10 / 6-8 BOSTON STREET TORQUAY PH 03 5261 3788

PROJECT & DWG No: AS CONTRUCTED A4041D-04-RD500

ABN 11 103 336 358 WWW.TOMKINSON.COM



MK SP MM CS 23/05/25

MK MK MM CS 01/10/24


NC MK MM 16/05/24

DES DWG CHK AUTH DATE







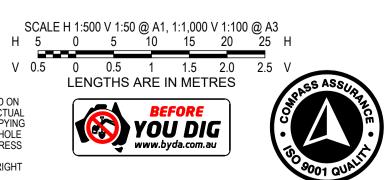

ESTUARY II - STAGE 04 PP-729-2021
ASH ROAD, LEOPOLD

ROAD AND DRAINAGE
ROAD LONGITUDINAL SECTIONS DELMARE DRIVE
AUTHORITY: CITY OF GREATER GEELONG

CLIENT: ASH ROAD LEOPOLD PTY LTD

DWG STATUS: PROJECT & DWG No:

AS CONTRUCTED A4041D-04-RD600

A PRELIMINARY ISSUE NC MK MM 16/05/24

REV REVISION DES DWG CHK AUTH DATE

AC1 AS CONSTRUCTED

B TITLE BLOCK UPDATED, TP'SADDED TO LONG SECTION



REVISION

DES DWG CHK AUTH DATE

10 / 6-8 BOSTON STREET TORQUAY PH 03 5261 3788
ABN 11 103 336 358 WWW.TOMKINSON.COM

DWG STATUS:

PROJECT & DWG No:

AS CONTRUCTED A4041D-04 - RD601

150mm FREEBOARD RL47.7 Q100 RL47.55		16.7%	2.0%	3.3%		-3.3%	3.3%		3.3%	2.0%	
RL 46.5								1			
DESIGN SURFACE	48.14	47.84	47.81	47.72	47.61	47.72	47.61	47.72	47.81	47.84	
CUT\FILL	0.00	0.24	0.22	0.23	0.32	0.10	0.08	-0.05	-0.25	-0.35	
EXIST SURFACE	48.14	48.08	48.03	47.95	47.93	47.82	47.69	47.67	47.56	47.49	
OFFSETS	-9.80	-8.00	-6.50	-3.80	-3.35	0.00	3.35	3.80	6.50	8.00	

CH 304.1

150mm FREEBOARD RL47.71 Q100 RL47.57			2.0%	3.3%		-3.3%	-3.3%		3.3%	2.0%	
RL 46.5											
DESIGN SURFACE	48.23	47.85	47.82	47.73	47.62	47.73	47.62	47.73	47.82	47.85	
CUT\FILL	0.00	0.30	0.28	0.29	0.38	0.16	0.15	0.02	-0.18	-0.28	
EXIST SURFACE	48.23	48.15	48.11	48.02	48.00	47.90	47.77	47.75	47.64	47.58	
OFFSETS	-10.26	-8.00	-6.50	-3.80	-3.35	0.00	3.35	3.80	6.50	8.00	

CH 296.18

150mm FREEBOARD RL47.6 Q100 RL47.5	4	16.7%	2.0%	3.3%	1	-3.3%	-3.3%		—— 3.3 %——	2.0%	
RL 46.0 DESIGN SURFACE	48.24	47.74	47.71	47.62	47.51	47.63	47.51	47.62	47.71	47.74	
CUT\FILL	0.14	0.54	0.51	0.51	09:0	0.37	0.35	0.22	0.02	-0.08	
EXIST SURFACE	48.39	48.28	48.23	48.13	48.11	48.00	47.86	47.85	47.74	47.66	
OFFSETS	-11.00	-8.00	-6.50	-3.80	-3.35	0:00	3.35	3.80	6.50	8:00	

CH 285.31

150mm FREEBOARD RL46.90 Q100 RL46.81	6	1 IN 10.6	2.0%	3.3%		-3.3%	-3.3%	<u>-</u>	5.0%	2.0%	16.7%	
RL 45.5	.29	00	26		78	2 68	82	68	05	47.05	31	
DESIGN SURFACE	47	47.00	46.97		46.78			46.89			47.31	
CUT\FILL	0.18	0.46	0.49	0.58	0 69	0.57	0.67	0.56	0.41	0.37	0.14	
EXIST SURFACE	47.47	47.47	47.47	47 46	47.46	47.45	47.45	47.44	47.43	47.42	47.41	
OFFSETS	-11.00	-8.00	-6.50	-380	-3.35	00:0	3.35	3.80	6.50	8.00	9.47	

CH 261.73


MK SP MM CS 23/05/25


150mm FREEBOARD RL47.7 Q100 RL47.55		16.7%	2.0%	3.3%		-3.3%	3.3%	7	3.3%	2.0%	\
RL 46.5											
DESIGN SURFACE	48.10	47.84	47.81	47.72	47.61	47.72	47.61	47.72	47.81	47.84	
CUT\FILL	0.00	0.21	0.19	0.20	0.30	0.08	0.05	-0.08	-0.28	-0.38	
EXIST SURFACE	48.10	48.05	48.00	47.91	47.90	47.80	47.66	47.64	47.53	47.46	
OFFSETS	-9.57	-8.00	-6.50	-3.80	-3.35	00:00	3.35	3.80	6.50	8.00	
						0110070					


CH 307.6

AG	23/05/25
SIGN	DATE
TOMKINSON GROUP 10/6-8 BOSTON RD, TORQUA	Y 3228
Sidney Glenister	23/05/25
SIGN	DATE

Tomkinson SURVEY | ENGINEERING | PLANNING | PROJECT MANAGEMENT

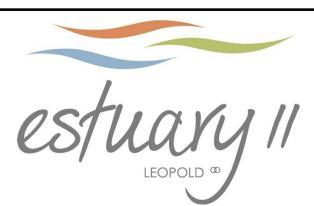

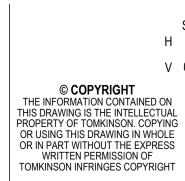


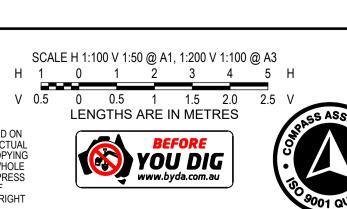




ROAD AND DRAINAGE
ROAD CROSS SECTIONS DELMARE DRIVE
AUTHORITY: CITY OF GREATER GEELONG
CLIENT: ASH ROAD LEOPOLD PTY LTD

AC1 AS CONSTRUCTED

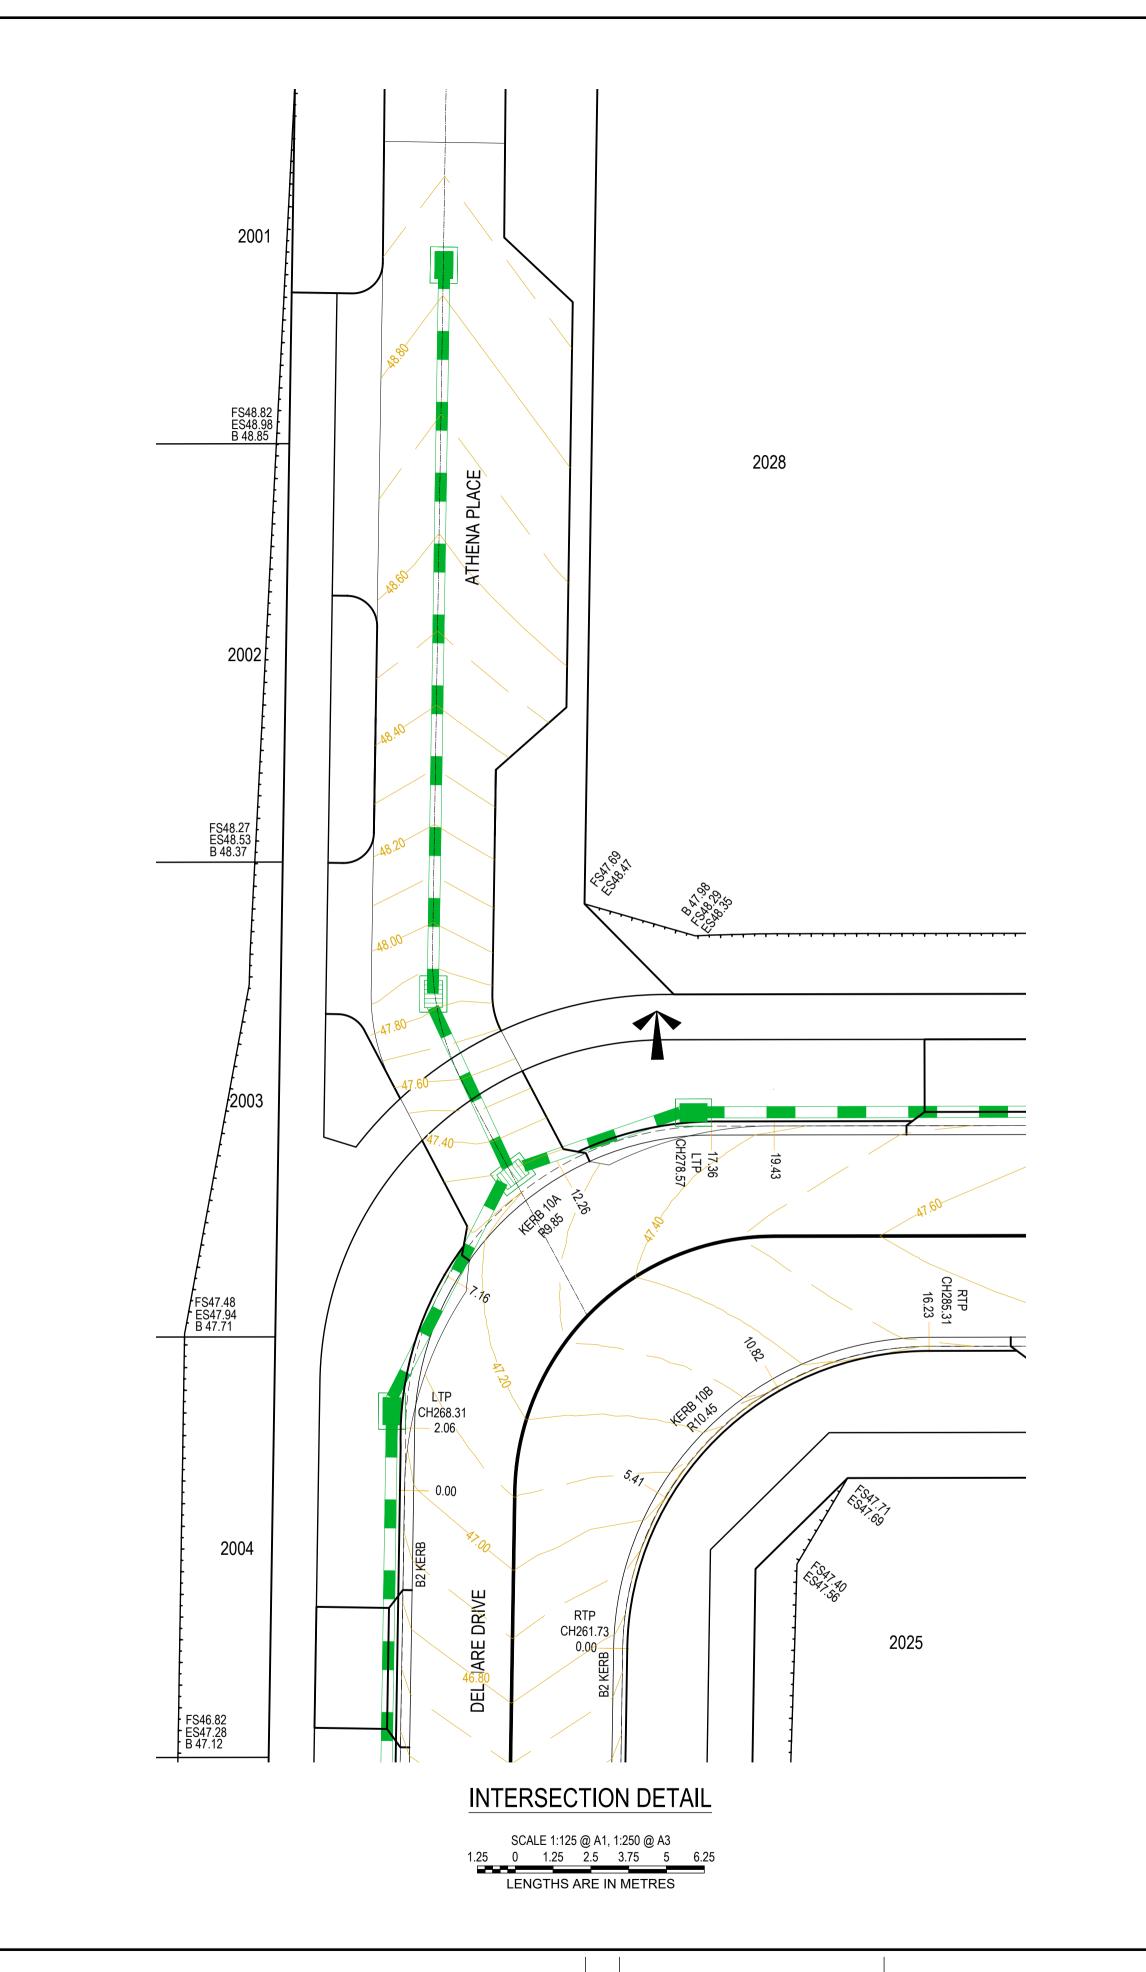


AS-CONSTRUCTED SIGNATURES 10/6-8 BOSTON RD, TORQUAY 3228 23/05/25 DRAPER'S CIVIL CONTRACTING PTY LTD

54-56 LEATHER ST, BREAKWATER VIC 3219

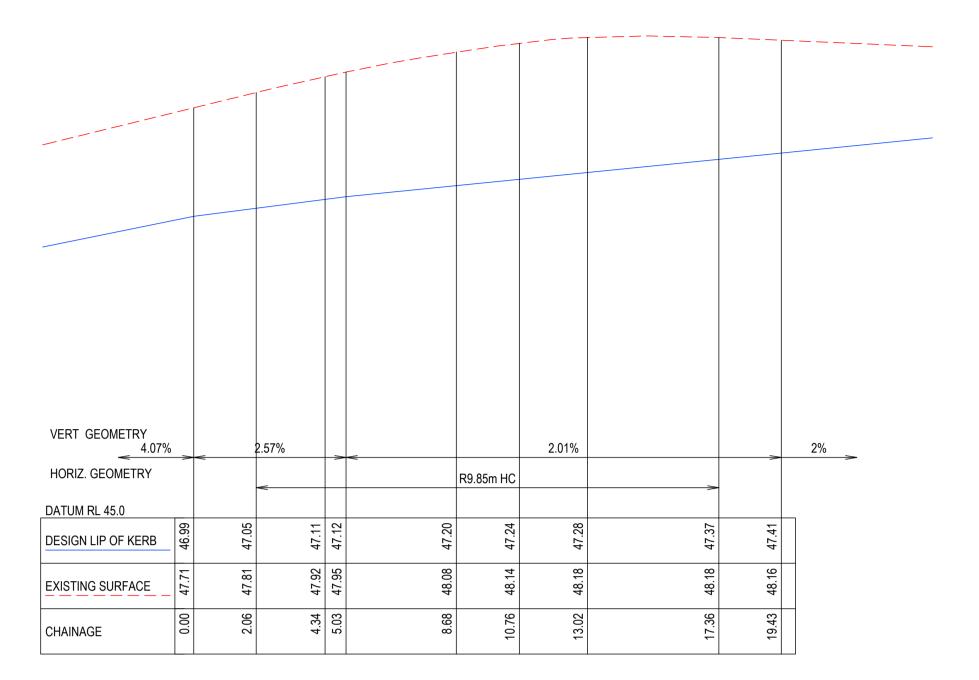

KERB 10A

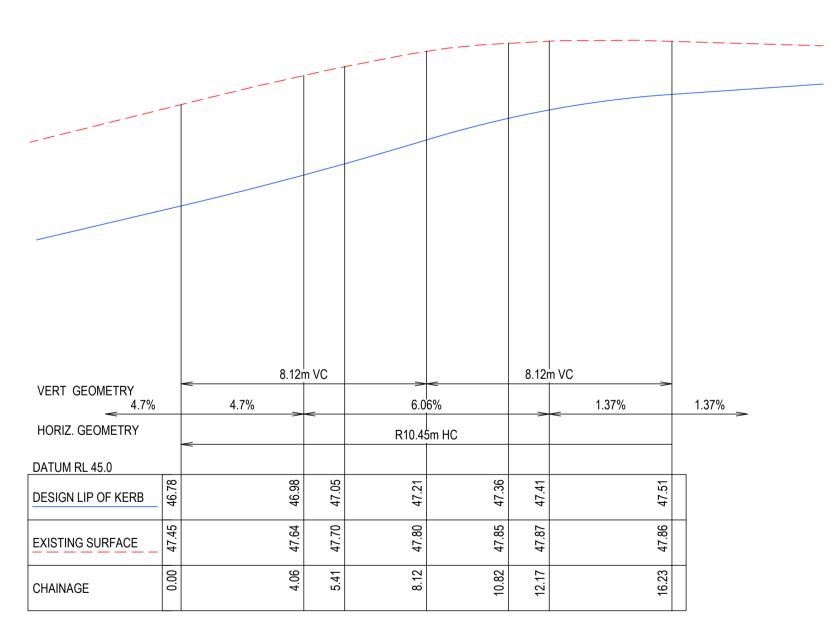

KERB 10B

SCALE 1:125 @ A1, 1:250 @ A3 1.25 0 1.25 2.5 3.75 5 6.25 LENGTHS ARE IN METRES

AC1 AS CONSTRUCTED MK SP MM CS 23/05/25 B TITLE BLOCK UPDATED MK MK MM CS 01/10/24 A PRELIMINARY ISSUE DES DWG CHK AUTH DATE REVISION






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ABN 11 103 336 358 WWW.TOMKINSON.COM





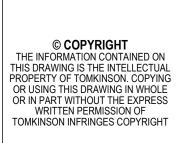


SCALE AS SHOWN



ESTUARY II - STAGE 04 PP-729-2021 ASH ROAD, LEOPOLD ROAD AND DRAINAGE
INTERSECTION DETAILS
AUTHORITY: CITY OF GREATER GEELONG
CLIENT: ASH ROAD LEOPOLD PTY LTD

PROJECT & DWG No:


AS CONTRUCTED A4041D-04-RD700

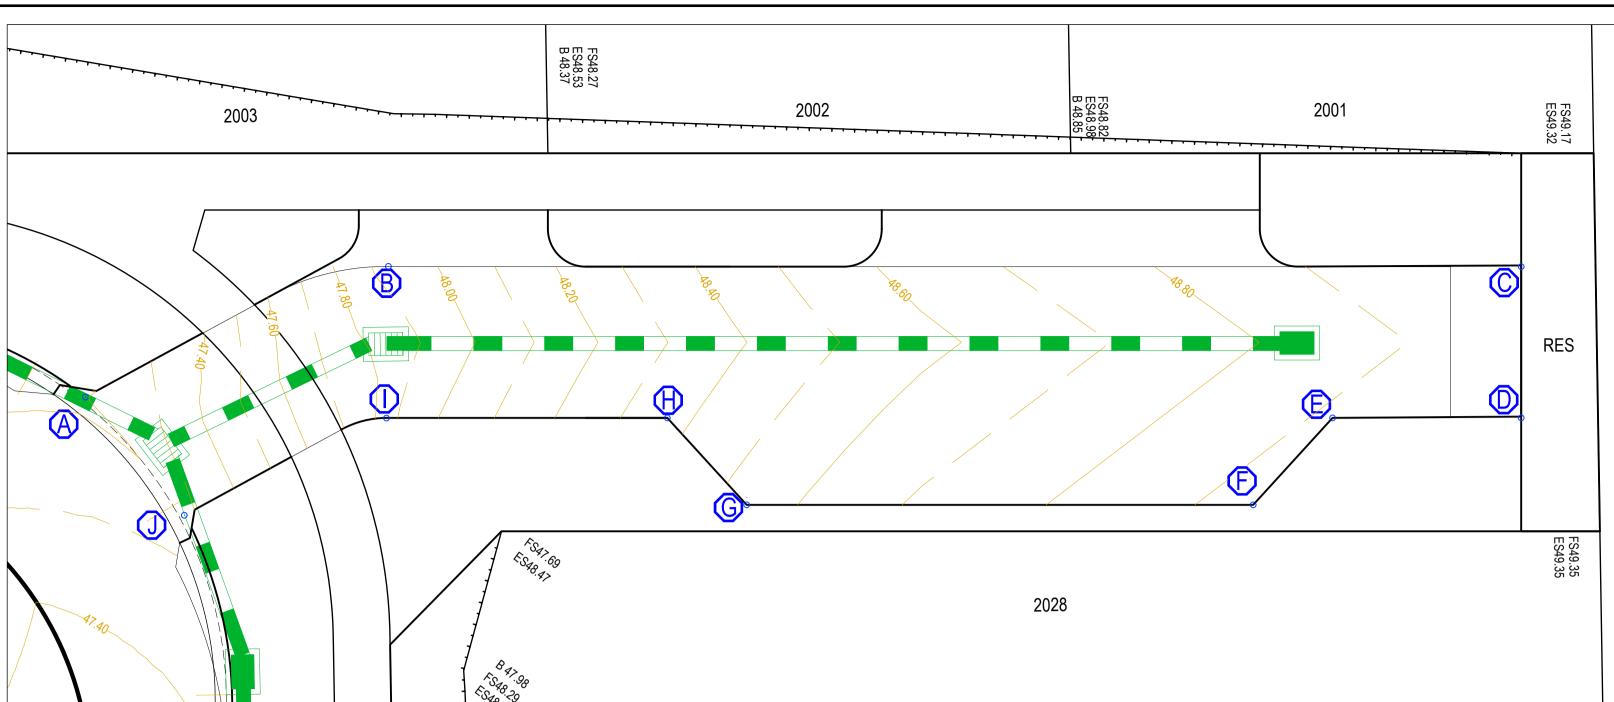


ATHENA PLACE SETOUT											
LOCATION	EASTING	NORTHING	RL								
А	277832.997	5769146.758	47.191								
В	277830.649	5769154.877	47.912								
С	277834.848	5769184.873	49.043								
D	277838.776	5769184.323	49.042								
E	277838.117	5769179.377	48.916								
F	277840.103	5769176.978	48.939								
G	277838.243	5769163.707	48.543								
Н	277835.673	5769161.947	48.366								

277834.718 5769153.553 277836.464 5769148.876 REFER TO IDM STANDARD DRAWINGS SD220 & SD225 FOR JOINT DETAILS

	28 CHA 62	SAG CR4.02 RL47.19								
		IP47.23	IP47.24			IP48.25		IP48.57		
DESIGN C.L.	-2	2.38%	V	9.5	2 56%	1.22	4m '	VC > 3.04% >	~	2.54%
HORIZ. GEOMETRY _DATUM RL 43.0				R=	9m ł	TC TC				
	47.34	47.24	47.19	47.23	47.58	47.93	48.08	48.12	48.67	48.98
DESIGN LEFT INSIDE \ ROADSIDE OF PATH		47.46	47.48	47.49	47.70	48.05	48.19	48.69	48.79	49.09
EDGE OF PAVEMENT RIGHT					47.60	48.00	48.14	48.19	48.82	49.04
EDGE OF PAVEMENT LEFT		47.19	47.21	47.22	47.49	48.00	48.14	48.19	48.81	49.04
EXISTING SURFACE	47.98	48.14	48.15	48.15					48.98	49.30
	0.00			4.78			15.39		29.96	41.87

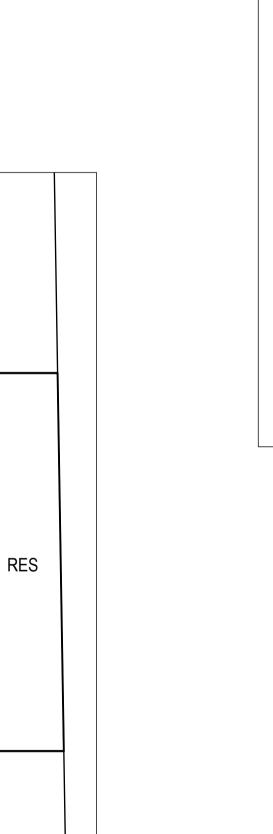

ATHENA PLACE LONGITUDINAL SECTION

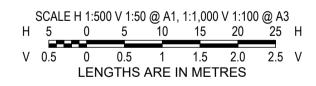




MK SP MM CS 23/05/25 AC1 AS CONSTRUCTED B TITLE BLOCK UPDATED MK MK MM CS 01/10/24 A PRELIMINARY ISSUE DES DWG CHK AUTH DATE REVISION

2003

3.02

3.68

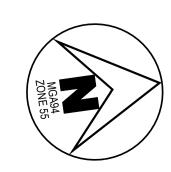

2002

3.66

ATHENA PLACE

2028

3.66



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LEGEND


2001

ISOLATION JOINT EXPANSION JOINT

WEAKENED PLANE JOINT

3.66




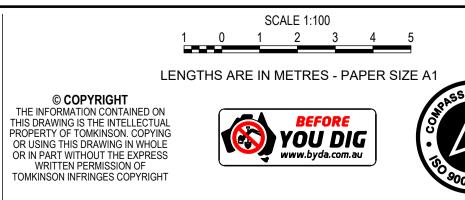

ESTUARY II - STAGE 04 PP-729-2021 ASH ROAD, LEOPOLD ROAD AND DRAINAGE
ATHENA PLACE SETOUT DETAILS
AUTHORITY: CITY OF GREATER GEELONG
CLIENT: ASH ROAD LEOPOLD PTY LTD

DWG STATUS: PROJECT & DWG No:

AS CONTRUCTED A4041D-04 - RD701

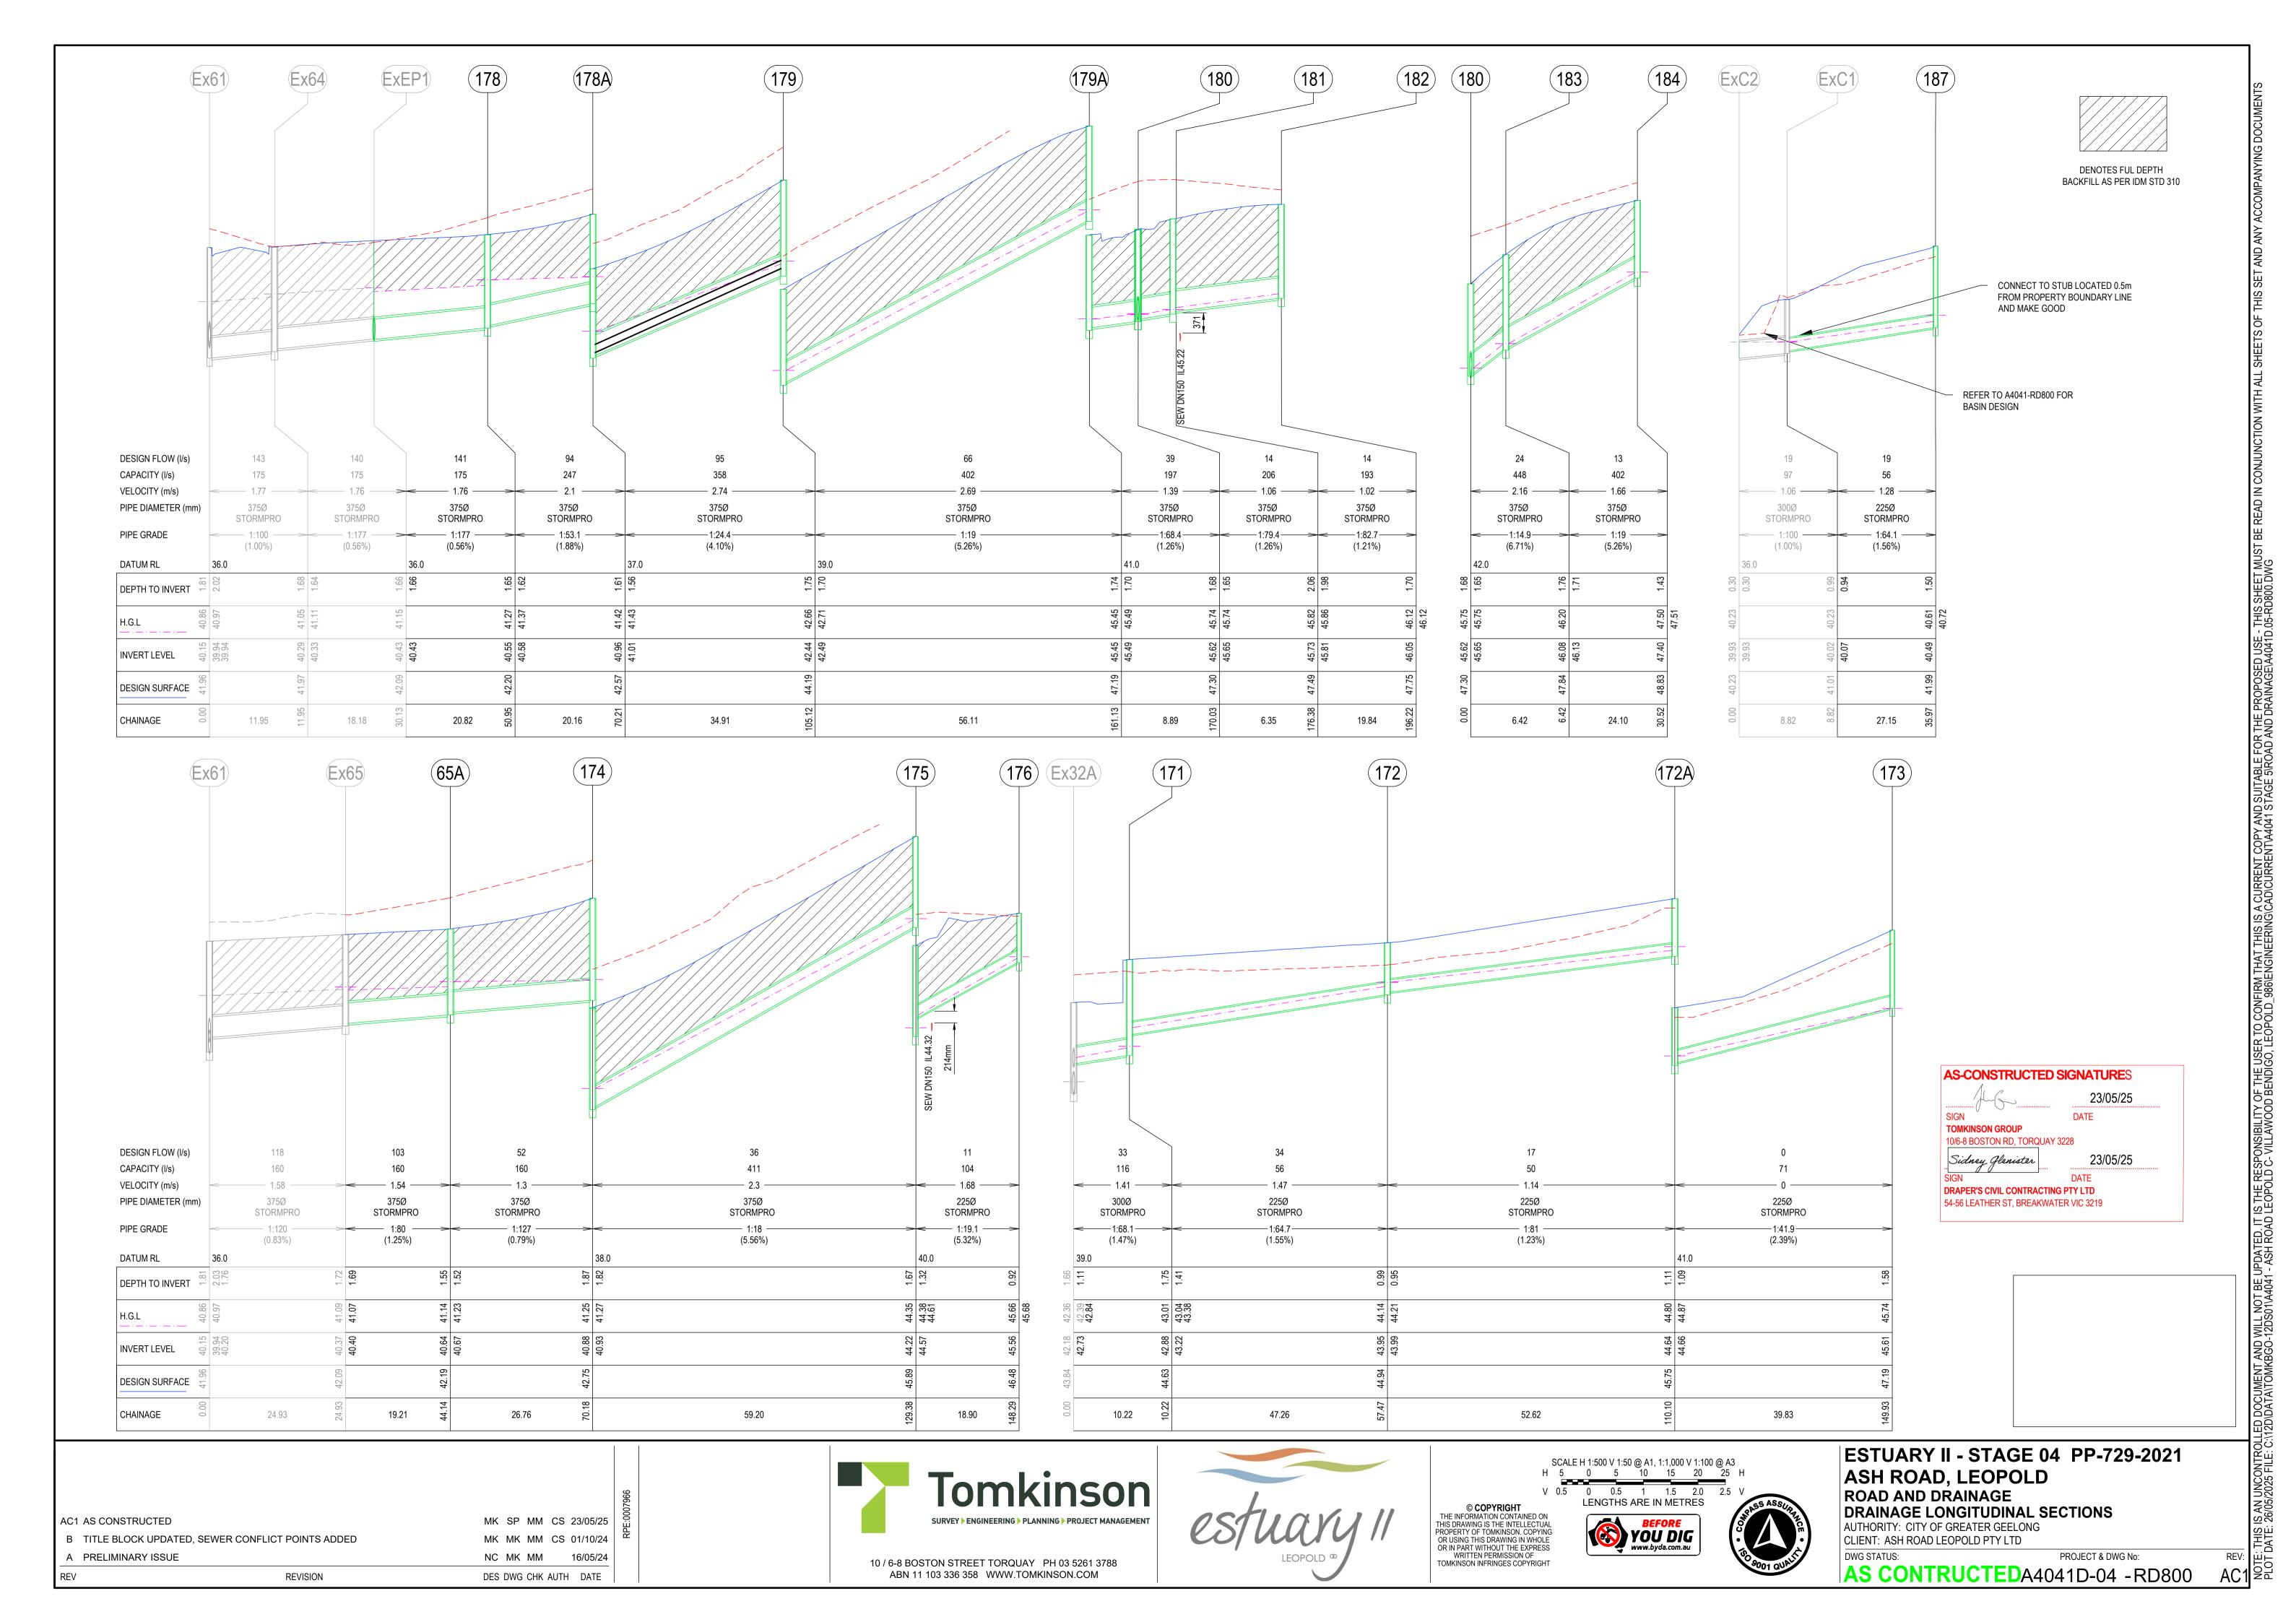

PIT SCHEDULE	
INLET OUTLET	PIT
DIAMETER INVERT DIAMETER LEVEL	SETOUT DEPTH REMARKS
300 42.73 375 42.18	43.84 CONTRACTOR TO BREAK INTO EX NORTH PIT WALL, CONNECT NEW PIPE AND MAKE GOOD REFER TO IDM SD405 & SD420
Ex 375 39.94 375 40.15	41.96 1.81 EX STAGE 1 JUNCTION PIT REFER TO IDM SD240
Ex 375 39.94	
Ex 375 40.33 375 40.29	41.97 1.68 EX STAGE 1 JUNCTION PIT REFER TO IDM SD240
Ex 375 40.43 375 40.43	42.09 1.66 END CAP
Ex 375 40.40 375 40.37	42.09 CONTRACTOR TO BREAK INTO EX NORTH PIT WALL, CONNECT NEW PIPE AND MAKE GOOD REFER TO IDM SD405 & SD420
375 40.67 375 40.64	42.19 1.55 REFER TO IDM SD405 & SD420
225 43.22 300 42.88	44.63 1.75 REFER TO IDM SD405 & SD420 WITH GRATED INSERT
225 43.99 225 43.95	44.94 0.99 REFER TO IDM SD405 & SD420 WITH GRATED INSERT
225 44.66 225 44.64	45.75 1.10 REFER TO IDM SD405 & SD420 WITH GRATED INSERT
225 45.61	47.19 1.58 REFER TO IDM SD405 & SD420 WITH GRATED INSERT
375 40.93 375 40.88	42.75 1.87 REFER TO IDM SD410 & SD430
375 44.57 375 44.22	45.89 1.67 REFER TO IDM SD405 & SD420
225 45.56	46.48 0.92 REFER TO IDM SD405 & SD420 PROVIDE GRATED PIT LID COVER
375 40.58 375 40.55	42.20 1.65 REFER TO IDM SD405 & SD420 PROVIDE CLASS D TRAFFICABLE LID
375 41.01 375 40.96	42.57 1.61 REFER TO IDM SD405 & SD420
375 42.49 375 42.44	44.19 1.75 REFER TO IDM SD405 & SD420
375 45.49 375 45.44	47.19 1.75 REFER TO IDM SD405 & SD420
375 45.65 375 45.62	47.30 1.68 REFER TO IDM SD410 & SD420 CLASS D BIKE SAFE GRATE MATCHED TO DWY PROFILE
375 45.65	
375 45.81 375 45.73	47.49 1.76 REFER TO IDM SD410 & SD420
375 46.05	47.75 1.70 REFER TO IDM SD405 & SD420
375 46.13 375 46.08	47.84 1.76 REFER TO IDM SD405 & SD420 CLASS D BIKE SAFE GRATE MATCHED TO DWY PROFILE
375 47.40	48.83 1.43 REFER TO IDM SD405 & SD420 PROVIDE CLASS D TRAFFICABLE LID
300 39.93	40.22 0.3 CONCRETE ENDWALL REFER IDM SD 498
300 40.07 300 40.02	41.01 0.99 REFER IDM SD 425
225 40.49	41.99 1.50 REFER TO SD405 & IDM SD425 PROVIDE GRATED COVER PIT LID

MK SP MM CS 23/05/25

MK MK MM CS 01/10/24

- ALL PIT LIDS TO BE REINFORCED FIBREGLASS CLASS C AS PER COGG DESIGN NOTE 13 UNLESS OTHERWISE STATED
- JP JUNCTION PIT
- GP GRATED PIT
- SEP SIDE ENTRY PIT - EW - END WALL

AS-CONSTRUCTED SIGNATURES


10/6-8 BOSTON RD, TORQUAY 3228

DRAPER'S CIVIL CONTRACTING PTY LTD 54-56 LEATHER ST, BREAKWATER VIC 3219



Tomkinson SURVEY | ENGINEERING | PLANNING | PROJECT MANAGEMENT




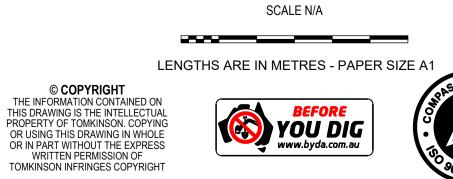

ESTUARY II - STAGE 04 PP-729-2021 ASH ROAD, LEOPOLD ROAD AND DRAINAGE
PIT SCHEDULE
AUTHORITY: CITY OF GREATER GEELONG
CLIENT: ASH ROAD LEOPOLD PTY LTD

AC1 AS CONSTRUCTED

B TITLE BLOCK UPDATED

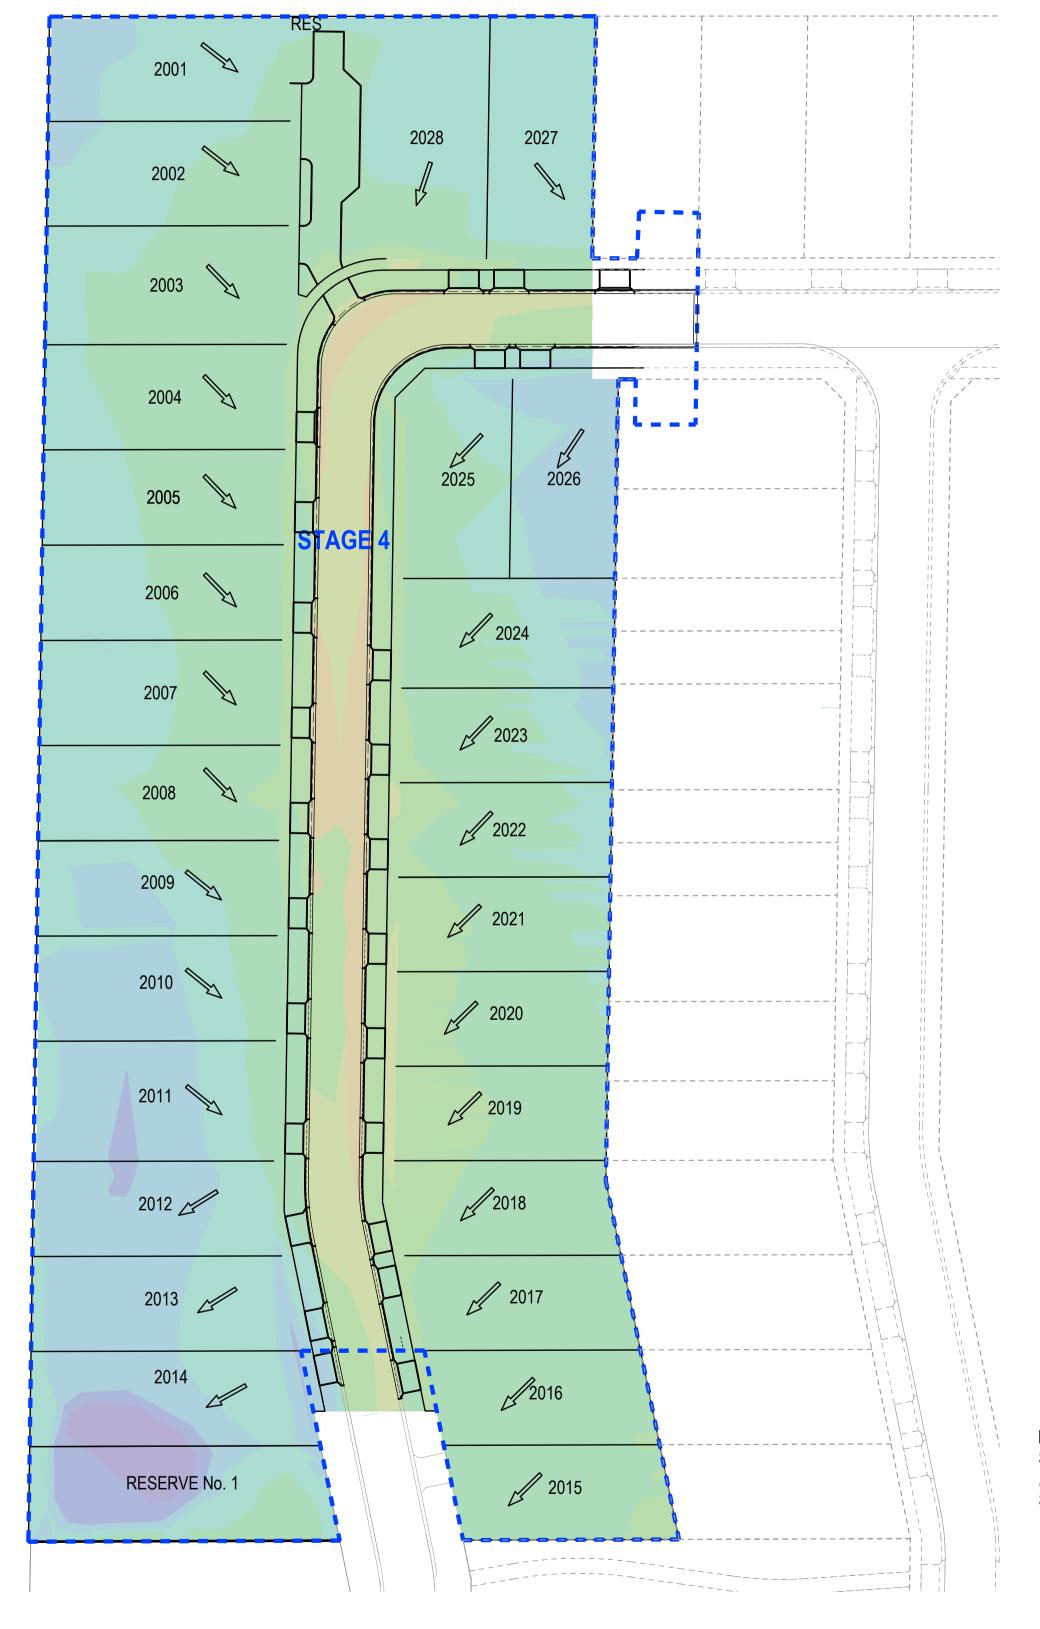

DES DWG CHK AUTH DATE

CUT & FIL	L DEPTH RA	ANGE					
LOWER VALUE	UPPER VALUE	COLOUR					
-3.5 to	o -2.5m						
-2.5 t	o 2.0m						
-2.0 to	o -1.5m						
-1.5 to	o -1.0m						
-1.0 to	o -0.6m						
-0.6 to	o -0.3m						
-0.3 t	o 0.1m						
0.1 -	- 0.3m						
0.3 -	- 0.6m						
0.6 -	- 1.0m						
1.0 -	1.0 - 1.5m						
1.5 -	· 2.0m						
2.0 -	- 2.5m						

CUT & FILL VOLUMES CUT = 1603m³ $FILL = 1771 m^3$

STRIPPING. VOLUMES HAVE BEEN CALCULATED FROM DESIGN SURFACE AGAINST STRIPPING WITHIN LOTS AND BOXING SURFACE AGAINST

NOTE: DEPTH RANGE CUT AND FILL ARE CALCULATED ALLOWING 200mm STRIPPING WITHIN ROAD RESERVE.

AC1 AS CONSTRUCTED MK SP MM CS 23/05/25 B TITLE BLOCK UPDATED A PRELIMINARY ISSUE

REVISION






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ABN 11 103 336 358 WWW.TOMKINSON.COM





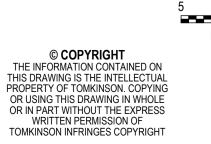



ESTUARY II - STAGE 04 PP-729-2021 ASH ROAD, LEOPOLD ROAD AND DRAINAGE
BULK EARTHWORKS
AUTHORITY: CITY OF GREATER GEELONG
CLIENT: ASH ROAD LEOPOLD PTY LTD

PROJECT & DWG No:

AS-CONSTRUCTED SIGNATURES

TOMKINSON GROUP


10/6-8 BOSTON RD, TORQUAY 3228


DRAPER'S CIVIL CONTRACTING PTY LTD 54-56 LEATHER ST, BREAKWATER VIC 3219

DATE

23/05/25


DWG STATUS: AS CONTRUCTED A4041D-04-RD900

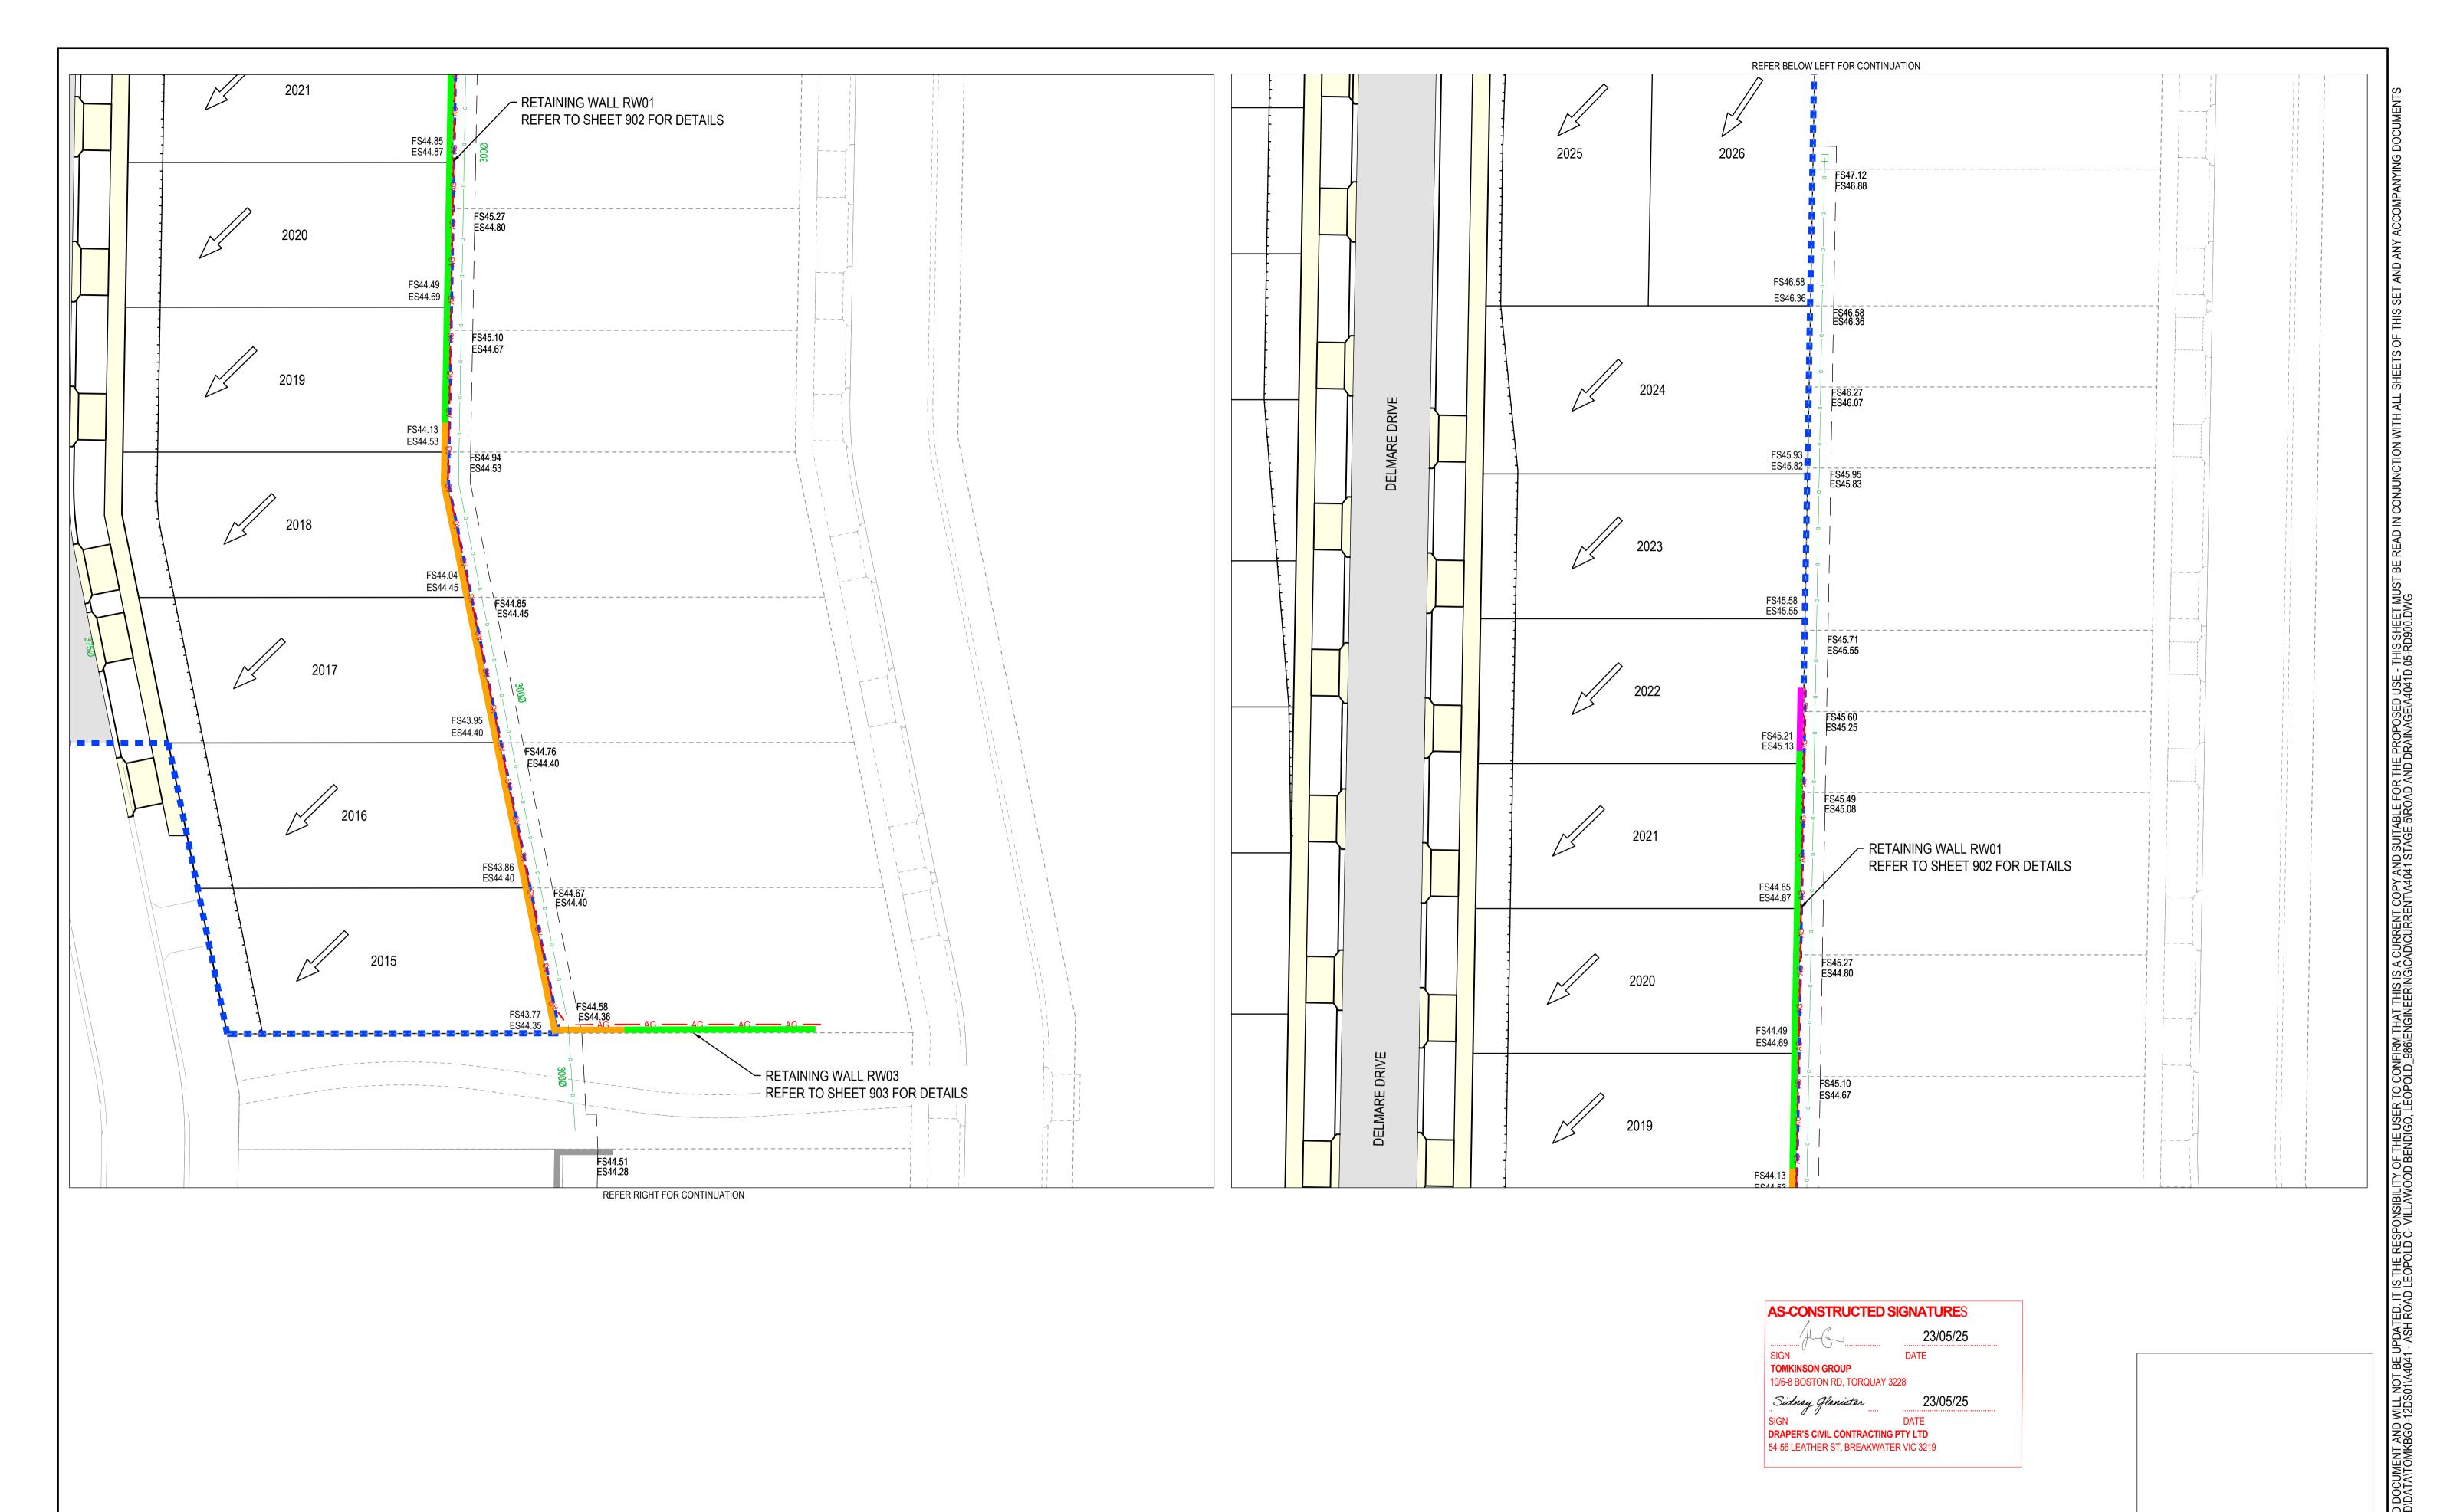


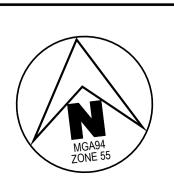





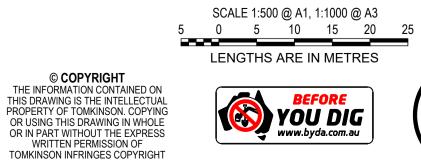


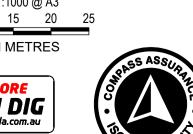

ESTUARY II - STAGE 04 PP-729-2021 ASH ROAD, LEOPOLD ROAD AND DRAINAGE
RETAINING WALL LAYOUT PLAN
AUTHORITY: CITY OF GREATER GEELONG
CLIENT: ASH ROAD LEOPOLD PTY LTD

AC1 AS CONSTRUCTED A PRELIMINARY ISSUE REVISION

MK SP MM CS 23/05/25 DES DWG CHK AUTH DATE

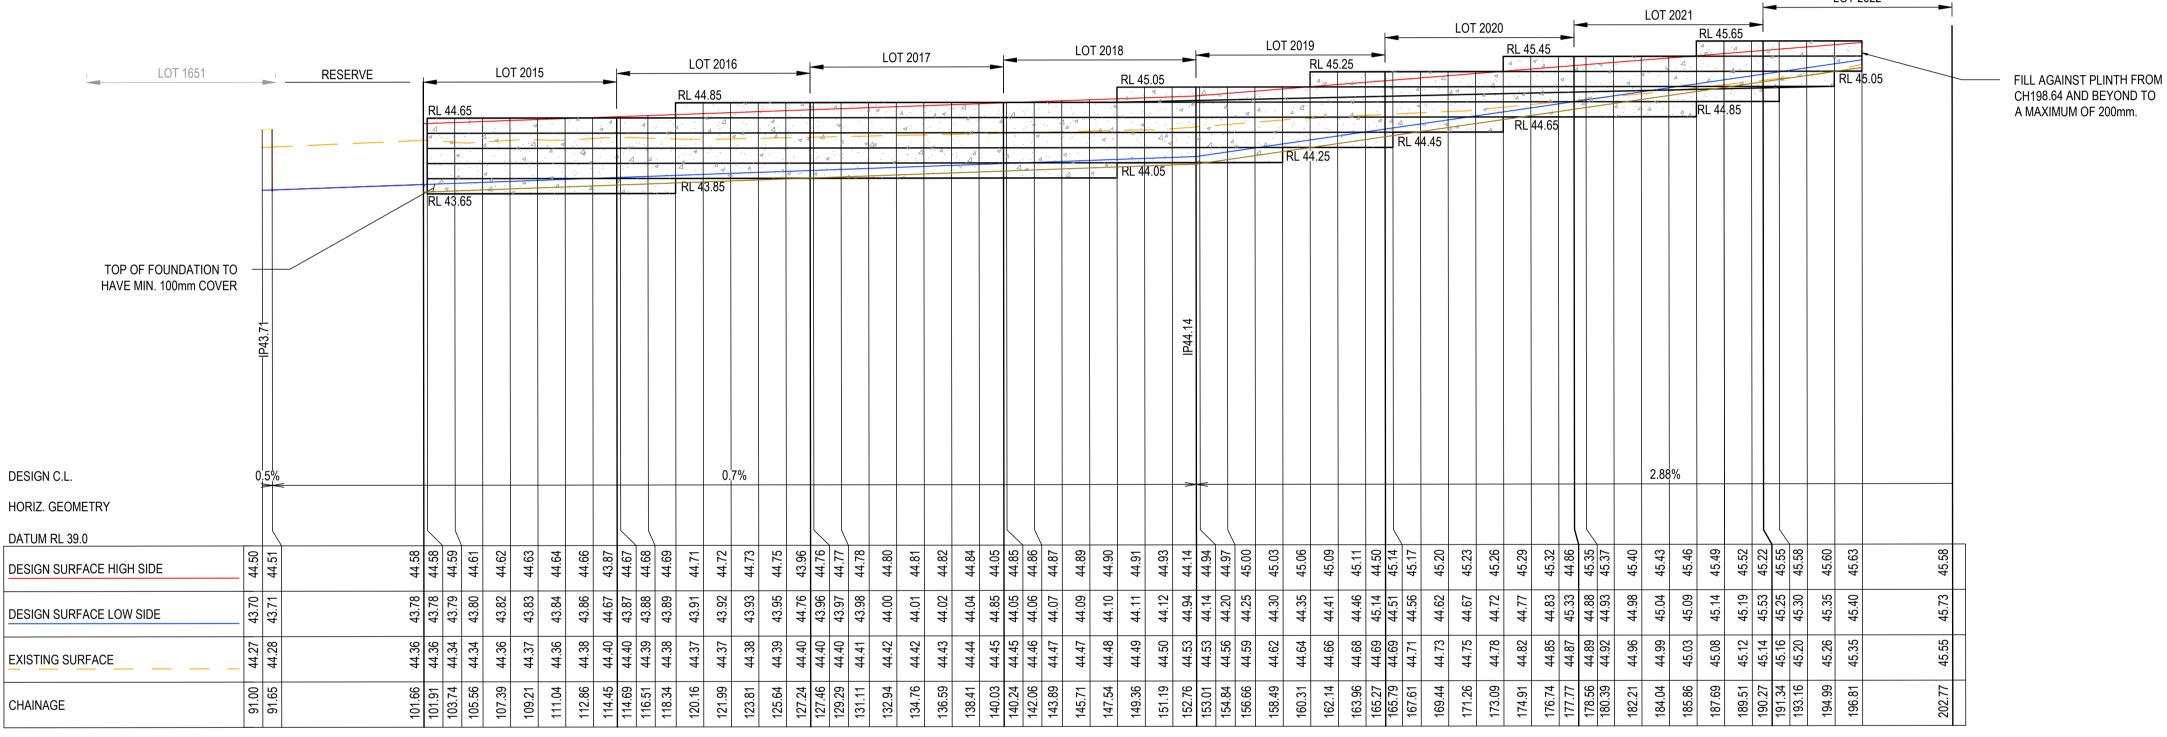

RETAINING WALL - RW01



 AC1
 AS CONSTRUCTED
 MK
 SP
 MM
 CS
 23/05/25

 1
 LOT NUMBERS/LONG SECTION CHAINAGES AMENDED & WALL LENGTH REDUCED
 MK
 MK
 MM
 CS
 28/10/24

 B
 TITLE BLOCK UPDATED
 MK
 MK
 MM
 CS
 01/10/24

 A
 PRELIMINARY ISSUE
 NC
 MK
 MM
 16/05/24


 REV
 REVISION
 DES
 DWS
 CHK
 AUTH
 DATE




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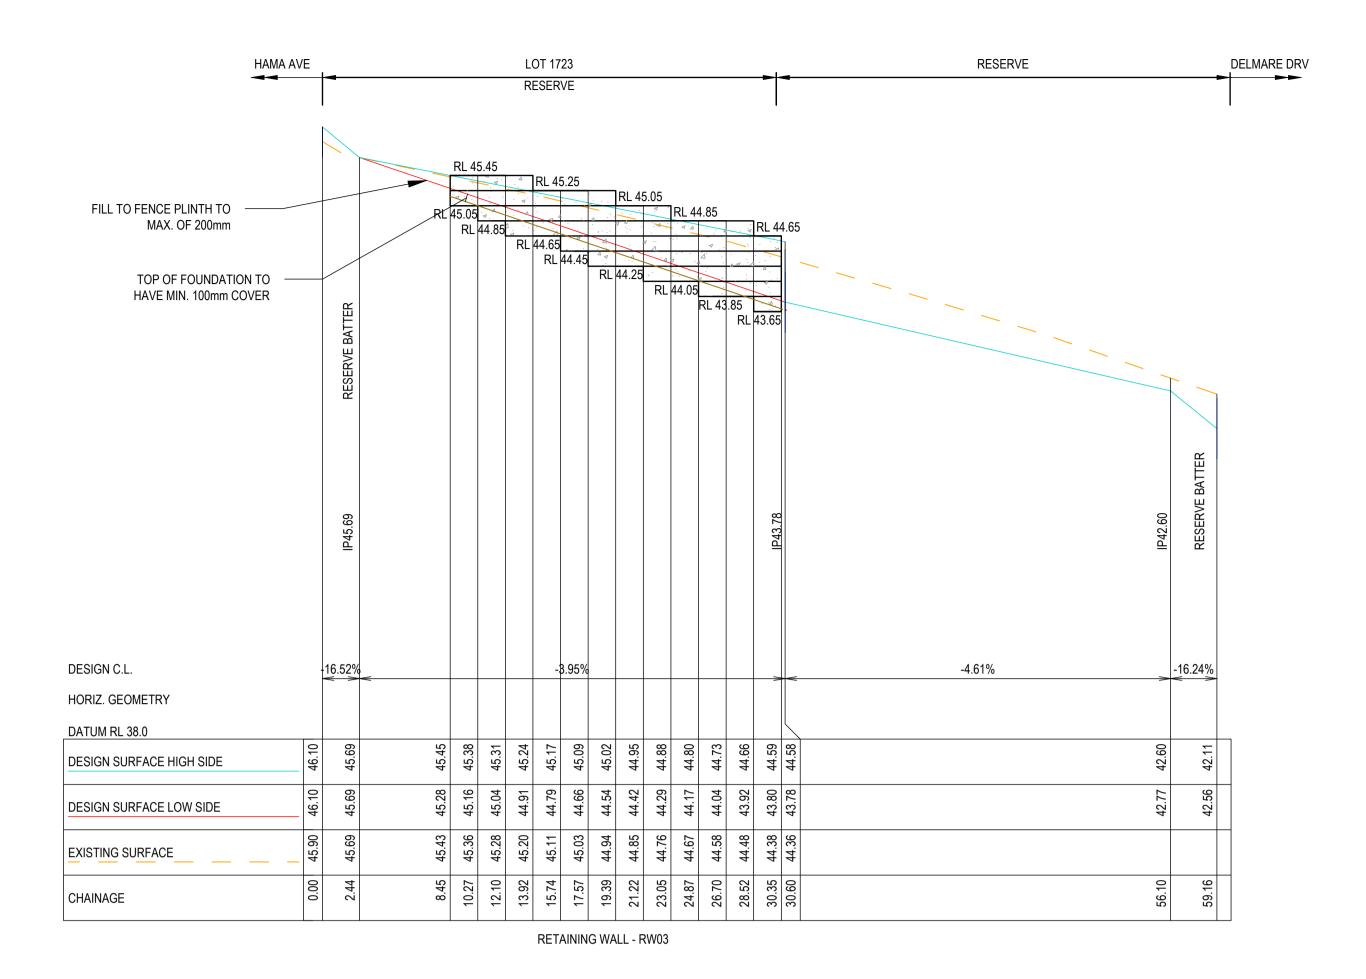


ESTUARY II - STAGE 04 PP-729-2021
ASH ROAD, LEOPOLD
ROAD AND DRAINAGE
RETAINING WALL LONGITUDINAL SECTION
AUTHORITY: CITY OF GREATER GEELONG
CLIENT: ASH ROAD LEOPOLD PTY LTD


DWG STATUS: PROJECT & DWG No:

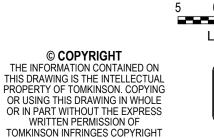AS CONTRUCTED A4041D-04-RD902

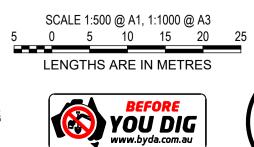T T S S NOTE: THIS IS AN UNCONTROLLED DOCUMENT AND WILL NOT BE UPDATED. IT IS THE RESPONSIBILITY OF THE USER TO CONFIRM THAT THIS IS A CURRE PLOT DATE: 26/05/2025 FILE: C:/12D\DATA\TOMKBGO-12DS01\A4041 - ASH ROAD LEOPOLD C- VILLAWOOD BENDIGO, LEOPOLD_986\ENGINEERING\CAD\CUR



SCALE H 1:500 V 1:100 @ A1, 1:1,000 V 1:200 @ A3 H 5 0 5 10 15 20 25 H V 1 0 1 2 3 4 5 V LENGTHS ARE IN METRES

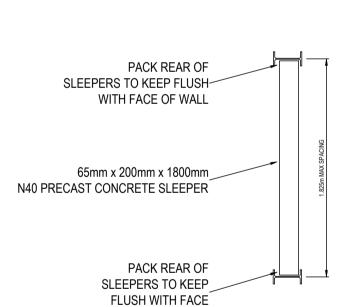


RETAINING WALL POST & EMBEDMENT SCHEDULE

OF WALL


EFFECTIVE HEIGHT 'H'		DEPTH OF EMBEDMENT 'D' DIA OF HOLE			COLUMN SIZE				
(m)	RC1	RC2	(m)	RC1	RC2				
0 - 0.4	0.90	0.90	0.45	100 UC 14.8	100 PFC	YES			
0.4 - 0.8	1.20	0.90	0.45	100 UC 14.8	100 PFC	YES			
0.8 - 1.0	1.50	1.20	0.45	100 UC 14.8	100 PFC	YES			

- 1 RC1 = INTERNAL COLUMN; RC2 = EXTERNAL COLUMN
- 2 ALL WALLS TO HAVE 20mm SCREENING BACKFILL IN 150mm WIDE TRENCH
- 3 ALL SCREENING BACKFILL/AG DRAINS TO HAVE POSITIVE DRAINAGE CONNECTION 4 ALL SLEEPERS TO BE 200mm DEEP x 65mm WIDE 1800mm MAX LENGTH PRECAST CONCRETE AS SPECIFIED
- 5 POSTS TO BE AT 1.825m MAX CENTRES AND ANTI-RUST TREATED
- 6 FACE OF RETAINING WALL TO BE 1:20 MIN
- 7 EMBEDMENT DEPTH IS TO BE WHOLLY IN SOLID NATURAL GROUND 8 WALL IS NOT DESIGNED TO SUPPORT ANY ADJACENT STRUCTURES
- 9 WALLS IN EXCESS OF 1.0m TO BE CERTIFIED BY A STRUCTURAL ENGINEER PRIOR TO CONSTRUCTION 10 REFER TO "RETAINING WALL DETAIL PLAN PREPARED BY SGP CONSULTING ENGINEERS REF 22-6681"
- WHEN CONSTRUCTING NEXT TO EXISTING/PROPOSED DRAINAGE

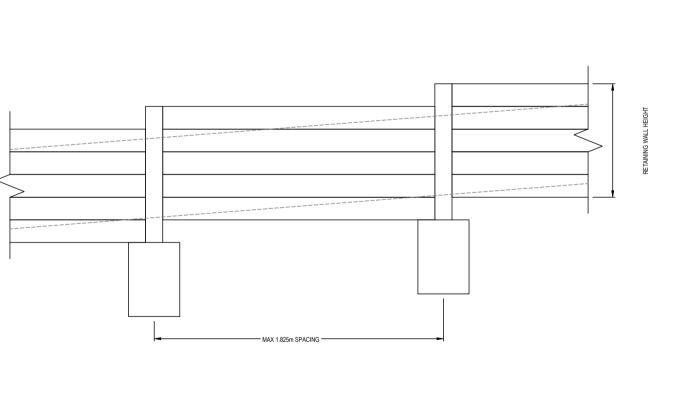



NOT TO SCALE

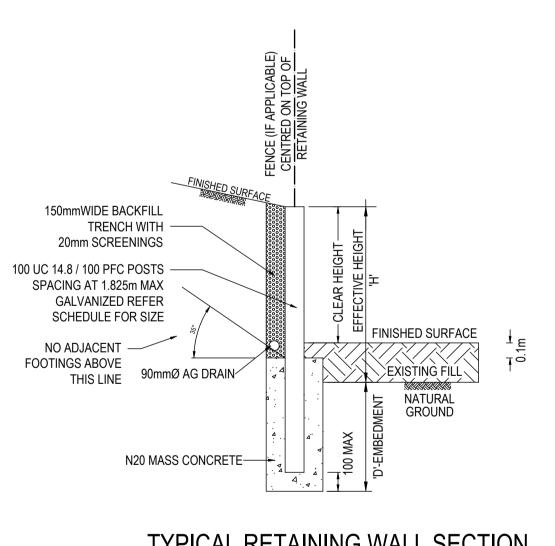

TYPICAL RETAINING WALL SECTION NOT TO SCALE

FINISHED SURFACE NATURAL SURFACE

AS-CONSTRUCTED SIGNATURES

SIGN

TOMKINSON GROUP

10/6-8 BOSTON RD, TORQUAY 3228

DRAPER'S CIVIL CONTRACTING PTY LTD 54-56 LEATHER ST, BREAKWATER VIC 3219

23/05/25


23/05/25


RETAINING WALL TYPICAL SECTION

NOT TO SCALE

REFER STRUCTURAL DETAILS REFERENCE 22-6681 PREPARED BY SGP CONSULTING ENGINEERS P/L FOR FULL RETAINING WALL SPECS AND DETAILS.



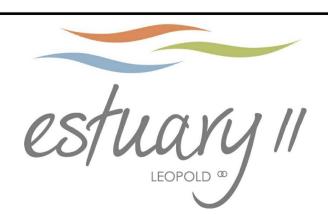

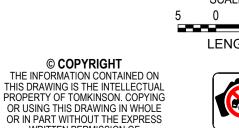





ESTUARY II - STAGE 04 PP-729-2021 ASH ROAD, LEOPOLD ROAD AND DRAINAGE RETAIING WALL LONGITUDINAL SECTION & DETAILS AUTHORITY: CITY OF GREATER GEELONG

CLIENT: ASH ROAD LEOPOLD PTY LTD

DWG STATUS: PROJECT & DWG No: AS CONTRUCTED A4041D-04-RD903

AC1 AS CONSTRUCTED MK SP MM CS 23/05/25 B TITLE BLOCK UPDATED A PRELIMINARY ISSUE REVISION DES DWG CHK AUTH DATE

